

SAN MATEO COUNTY CALIFORNIA

MIDCOAST MULTI-MODAL TRAIL IMPROVEMENTS PROJECT

IN SAN MATEO COUNTY

TOTAL PROJECT LENGTH APPROXIMATELY 0.86 MILES

TO BE SUPPLEMENTED BY STATE OF CALIFORNIA DEPARTMENT OF TRANSPORTATION STANDARD PLANS DATED MAY 2006 AND ADOPTED BY SAN MATEO COUNTY, NOVEMBER 14, 2006, BY RESOLUTION NO. 068389



APPROVED

JAMES C PORTER DIRECTOR OF PURILC WOR

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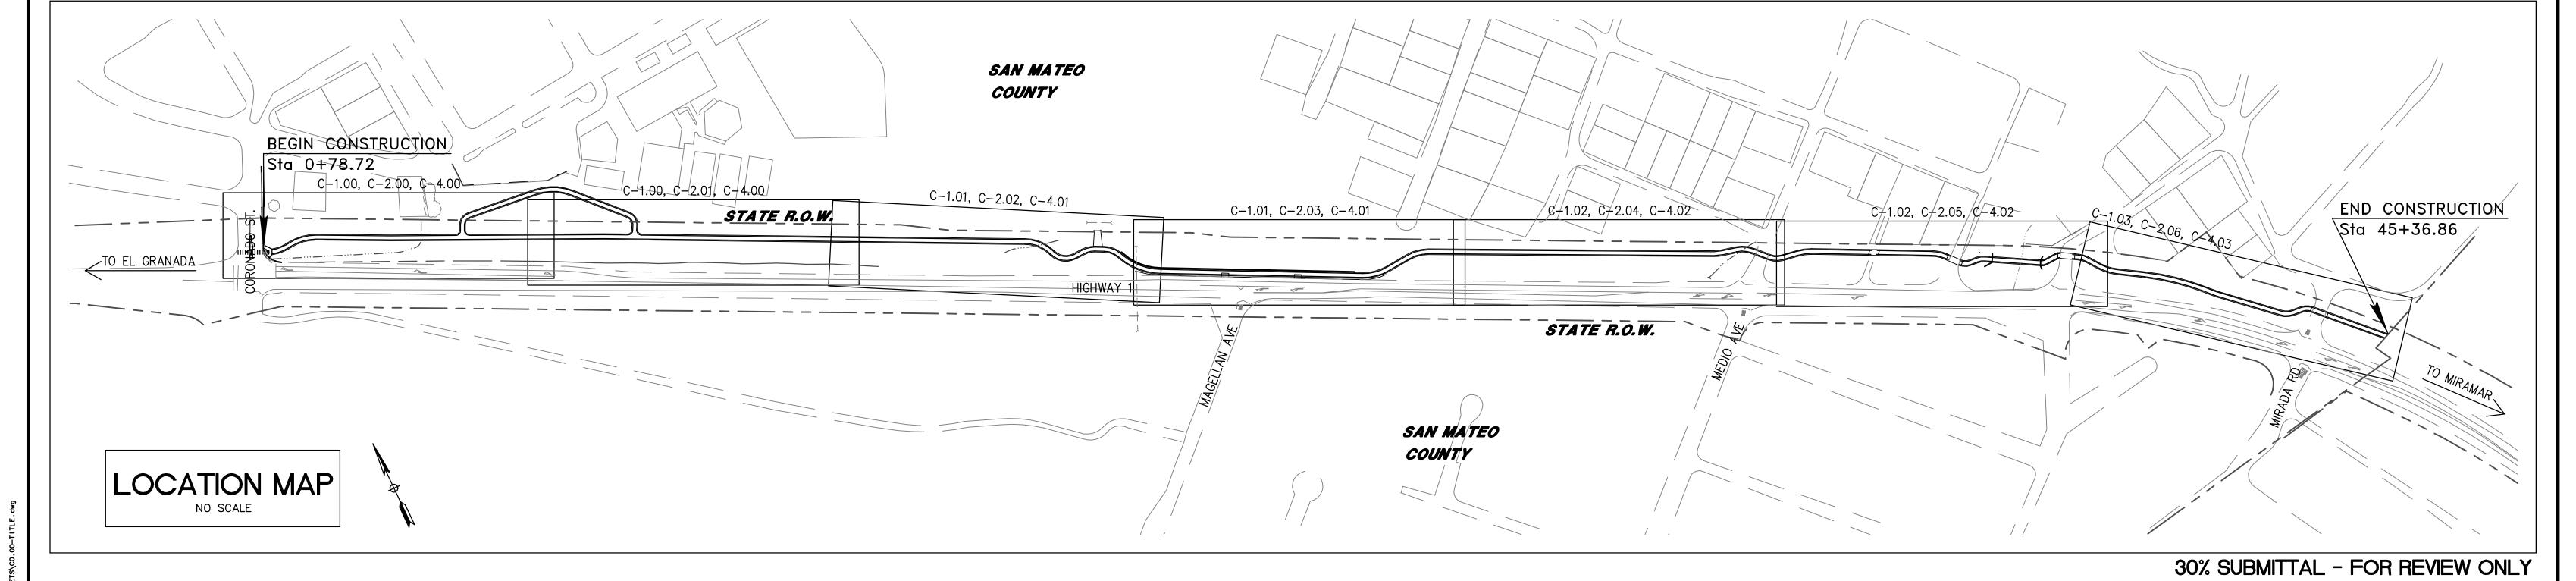
C-5.00 EROSION CONTROL PLAN

C-6.00 DETAILS

C-6.01 DETAILS

1 GENERAL PLAN – BRIDGE

2 GENERAL PLAN — RETAINING WALL



APPROVED DATE:

JASON MANSFIELD, PROJECT MANAGER

BKF ENGINEERS

R.C.E. # 59567 / EXPIRES 12–31–2017

ENGINEERS / SURVEYORS / PLANNERS

255 SHORELINE DRIVE, SUITE 200
REDWOOD CITY, CA 94065
(650) 482-6300

DESIGNED BY: CT MIDCOAST MUI

CHECKED BY: JM TITLE

DRAWN BY: FC

JAMES C. PORTER, DIRECTOR OF PUBLIC WORKS

SAN MATEO COUNTY

FOR REDUCED PLANS
ORIGINAL SCALE IS IN INCHES

MIDCOAST MUI

TITLE

DRAWN BY: FC

JAMES C. PORTER, DIRECTOR OF PUBLIC WORKS

SAN MATEO COUNTY

MIDCOAST MULTI-MODAL TRAIL

TITLE SHEET

DATE: 5/20/16

FILE NO.: 1/XXXX

DE PUBLIC WORKS

555 COUNTY CENTER, 5th FLOOR

REDWOOD CITY, CALIFORNIA 94063

C-0.00
SHEET 1 OF 24

PROJECT DESCRIPTION:

PHYSICAL DESCRIPTION OF SITE: TRAIL ALONG HIGHWAY 1.

SAN MATEO COUNTY ALONG HIGHWAY 1 BETWEEN CORONADO STREET AND MIRADA ROAD.

<u>UTILITIES:</u> STORM DRAIN:

COUNTY OF SAN MATEO COASTSIDE COUNTY WATER DISTRICT WATER: SANITARY SEWER: SEWER AUTHORITY MID-COASTSIDE GRANADA SANITARY DISTRICT PACIFIC GAS & ELECTRIC

GAS/ELECTRIC:

GEOTECHNICAL REPORT PREPARED BY PARIKH CONSULTANTS, INC. TITLED _____ AND DATED _____

ESTIMATED EARTHWORK:

 $FILL = XXXX CY \pm$

CONTRACTOR SHALL BE RESPONSIBLE FOR VERIFYING ALL FINAL QUANTITIES.

REQUIRED PERMITS:

- COUNTY OF SAN MATEO ENCROACHMENT PERMIT
- CALTRANS ENCROACHMENT PERMIT
- ENVIRONMNENTAL PERMIT

EXISTING TOPOGRAPHY

THE EXISTING TOPOGRAPHY IS BASED ON AN AERIAL LIDAR PERFORMED BY UNITED STATES GEOLOGICAL SURVEY DATED 14-JUL-2010.

PROJECT NOTES:

2. ENVIRONMENTAL CONSULTANT

1. CIVIL ENGINEER

6. COUNTY

BKF ENGINEERS 255 SHORELINE DRIVE, SUITE 200 REDWOOD CITY, CA 94065

TEL 650.482.6300

PLACEWORKS

1625 SHATTUCK AVE #300 BERKELEY, CA 94709

TEL 510.848.3815

3. STRUCTURAL ENGINEER CORNERSTONE STRUCTURAL ENGINEERING GROUP

40 FEDERAL STREET SAN FRANCISCO, CA 94107 TEL 415.369.9100

4. TRANSPORTATION ENGINEER FEHR & PEERS

332 PINE STREET, 4TH FLOOR SAN FRANCISCO, CA 94104

415.348.0300 5. GEOTECHNICAL ENGINEER

PARIKH CONSULTANTS, INC. 2360 QUME DRIVE, SUITE A

SAN JOSE, CA 95131 408.452.9000

COUNTY OF SAN MATEO

TEL 650.363.4100

555 COUNTY CENTER, 5TH FLOOR REDWOOD CITY, CA 94063

7. THE FOLLOWING NOTES ARE ESTABLISHED MERELY TO GUIDE THE CONTRACTOR AS TO THE GENERAL ITEMS OF WORK INVOLVED AND ARE NOT INTENDED TO COVER COMPLETE SCOPE OF WORK. CONTRACTOR SHALL COMPLETE ALL WORK AS PER CONTRACT DOCUMENTS.

8. CONSTRUCTION CONTRACTOR AGREES THAT IN ACCORDANCE WITH GENERALLY ACCEPTED CONSTRUCTION PRACTICES, CONSTRUCTION CONTRACTOR WILL BE REQUIRED TO ASSUME SOLE AND COMPLETE RESPONSIBILITY FOR PERSONS AND PROPERTY THAT IS REQUIREMENT SHALL BE MADE TO APPLY CONTINUOUSLY AND NOT BE AND HOLD DESIGN PROFESSIONAL HARMLESS FROM ANY AND ALL LIABILITY, REAL OR ALLEGED, IN CONJUNCTION WITH THE PERFORMANCE OF WORK ON THIS PROJECT, EXCEPTING LIABILITY ARISING FROM THE SOLE NEGLIGENCE OF DESIGN PROFESSIONAL.

9. ALL MATERIALS, WORK APPURTENANCES SHALL CONFORM WITH THESE PLANS, THE PROJECT SPECIFICATIONS AND THE LATEST ADOPTED VERSION OF SAN MATEO COUNTY STANDARD DETAILS.

10. THE CONTRACTOR SHALL AT ALL TIMES COMPLY WITH THE RULES AND REGULATIONS ESTABLISHED BY CAL-OSHA AND OTHER AGENCIES HAVING JURISDICTION OVER THE WORK.

11. THE CONTRACTOR SHALL NOT DESTROY ANY PERMANENT SURVEY POINTS WITHOUT THE CONSENT OF THE COUNTY. ANY PERMANENT MONUMENTS OR POINTS DESTROYED SHALL BE REPLACED BY A REGISTERED CIVIL ENGINEER OR LICENSED LAND SURVEYOR AT THE CONTRACTOR'S EXPENSE.

12. THE CONTRACTOR IS RESPONSIBLE FOR MATCHING EXISTING ROADWAYS, SURROUNDING LANDSCAPE AND OTHER IMPROVEMENTS WITH A SMOOTH TRANSITION IN PAVING, CURBS, GUTTERS, SIDEWALKS, GRADING, ETC. AND TO AVOID ANY ABRUPT OR APPARENT CHANGES IN GRADES OR CROSS SLOPES, LOW SPOTS OR HAZARDOUS CONDITIONS.

13. THE LOCATIONS AND TYPES OF EXISTING UTILITIES SHOWN ON THE PLANS ARE BASED ON INFORMATION FURNISHED BY SERVICING AGENCIES AND FIELD SURVEY. IT IS THE CONTRACTOR'S RESPONSIBILITY TO FIELD VERIFY THE POSITION OF AND PROVIDE PROTECTION FOR SUCH UTILITIES AND STRUCTURES, WHETHER SHOWN ON THE PLAN OR NOT.

14. IT SHALL BE THE CONTRACTOR'S RESPONSIBILITY TO IMMEDIATELY NOTIFY THE ENGINEER UPON DISCOVERY OF ANY FIELD CONFLICTS.

15. THE CONTRACTOR SHALL BE HELD RESPONSIBLE FOR ANY FIELD CHANGES DONE WITHOUT WRITTEN AUTHORIZATION FROM THE

16. ANY DEVIATIONS OR CHANGES IN THESE PLANS WITHOUT WRITTEN APPROVAL OF THE ENGINEER SHALL BE AT THE CONTRACTOR'S OWN RISK.

17. PRIOR TO CONSTRUCTION, THE CONTRACTOR SHALL FIELD VERIFY ALL DIMENSIONS SHOWN.

18. CONTRACTOR IS ADVISED THAT EXISTING UTILITY LINES IN SOME LOCATIONS MAY BE VERY CLOSE TO TRAIL CONSTRUCTION WORK. CONTRACTOR IS TO SUPPORT THESE UTILITIES DURING CONSTRUCTION AND ANY REQUIRED OR SPECIAL CONSTRUCTION TECHNIQUES PERFORMED SHALL BE AT NO EXTRA COST TO THE COUNTY. COMPENSATION FOR THIS WORK SHALL BE INCLUDED IN THE UNIT PRICES PAID FOR THE VARIOUS CONTRACT ITEMS OF WORK, AND NO ADDITIONAL COMPENSATION WILL BE ALLOWED THEREFORE.

PROJECT NOTES (CONTINUED):

- 18. ALL GRADING AND EARTHWORK SHALL BE CARRIED OUT IN CONFORMANCE WITH THE RECOMMENDATIONS CONTAINED IN THE GEOTECHNICAL REPORT BYPARIKH CONSULTANTS, INC TITLED _____ DATED _____
- 19. ELEVATIONS AND LOCATIONS OF ALL EXISTING UTILITY CROSSINGS SHALL BE VERIFIED BY THE CONTRACTOR PRIOR TO START OF ANY CONSTRUCTION AFFECTING SAID LINES. CONTACT USA AT (800) 642-2444 AT LEAST TWO WORKING DAYS PRIOR TO EXCAVATION.
- 20. CONTRACTOR SHALL CONFINE HIS OPERATIONS AND ACTIVITIES WITHIN THE PROJECT LIMITS, CONSISTING OF ROAD RIGHT-OF-WAY, UTILITY EASEMENTS, AND/OR PROJECT CONFORMS, AS SHOWN ON THE PLANS.
- 21. THE CONTRACTOR SHALL RESTORE ALL DAMAGED, REMOVED OR OTHERWISE DISTURBED WALLS, FENCES, SERVICES, UTILITIES, IMPROVEMENTS OR FEATURES OF WHATEVER NATURE, DUE TO CONTRACTOR'S WORK. SEPARATE PAYMENT FOR RESTORATION OF EXISTING IMPROVEMENTS TO THEIR ORIGINAL CONDITION WILL NOT BE MADE. COMPENSATION FOR THIS TASK SHALL BE CONSIDERED AS INCLUDED IN THE VARIOUS CONTRACT ITEMS OF WORK INVOLVED.
- 22. ALL PERMANENT MONUMENTS DISTURBED DURING THE PROCESS OF CONSTRUCTION SHALL BE REPLACED BEFORE ACCEPTANCE OF THE IMPROVEMENTS BY THE COUNTY ENGINEER.
- 23. THE CONTRACTOR SHALL GIVE THE COUNTY ENGINEER TWO WORKING DAYS ADVANCE NOTICE FOR INSPECTION.
- 24. VEGETATION AND IMPROVEMENTS SHALL BE REMOVED ONLY WHEN DIRECTED IN WRITING BY THE ENGINEER. NO TREES, VEGETATION, OR IMPROVEMENTS (INCLUDING FENCES) SHALL BE REMOVED WITHOUT PRIOR WRITTEN CONSENT AND APPROVAL OF THE ENGINEER.
- 25. CONTRACTOR SHALL EXERCISE CARE WHEN EXCAVATING NEAR TREES AND ROOTS OF TREES TO REMAIN. HAND EXCAVATION MAY BE REQUIRED FOR TREES IN CLOSE PROXIMITY TO THE TRAIL.
- 26. CONTINUOUS DUST CONTROL SHALL BE PROVIDED AS REQUIRED BY SECTION 10 "DUST CONTROL," OF THE STANDARD SPECIFICATIONS AND AS DIRECTED BY THE ENGINEER.
- 27. THE CONTRACTOR SHALL FURNISH ALL AFFECTED PROPERTY OWNERS AND/OR RESIDENTS WRITTEN NOTIFICATIONS IN ACCORDANCE WITH SECTION 11, "MOBILIZATION," OF THE SPECIAL PROVISIONS.
- 28. THE CONTRACTOR SHALL FURNISH AND IMPLEMENT A WATER POLLUTION CONTROL PROGRAM FOR ALL PHASES OF WORK IN ACCORDANCE WITH SECTION 11-1, "WATER POLLUTION CONTROL," OF THE SPECIAL PROVISIONS.
- 29. THE CONTRACTOR SHALL FURNISH AND IMPLEMENT A TRAFFIC CONTROL PLAN FOR ALL PHASES OF WORK IN ACCORDANCE WITH SECTION 12. "MAINTAINING TRAFFIC," OF THE SPECIAL PROVISIONS.
- 30. NO TRENCHES OR HOLES SHALL BE LEFT OPEN OVERNIGHT, USE STEEL PLATING OR HOT-MIX ASPHALT AS REQUIRED TO PROTECT OPEN TRENCHES OVERNIGHT.
- 31. STAGING AREAS FOR EQUIPMENT AND MATERIALS STORAGE SHALL BE LOCATED IN PUBLIC ROAD RIGHT-OF-WAY WITH SAID LOCATION SUBJECT TO THE APPROVAL OF THE ENGINEER AND/OR CALTRANS.
- 32. ALL REVISIONS TO THIS PLAN MUST BE REVIEWED AND APPROVED BY THE COUNTY ENGINEER PRIOR TO CONSTRUCTION AND SHALL BE ACCURATELY SHOWN ON REVISED PLANS STAMPED AND SIGNED BY COUNTY ENGINEER PRIOR TO THE INSTALLATION OF THE IMPROVEMENTS.
- 33. CONTRACTOR SHALL PROTECT AND CLEANOUT ALL EXISTING CULVERT CROSSINGS WITH LIMITS OF AC TRAIL CONSTRUCTION.

GENERAL CONSTRUCTION NOTES:

IN ACCORDANCE WITH THE NPDES PERMIT COMPLIANCE CHECKLIST FOR THE COUNTY OF SAN MATEO. THE CONTRACTOR SHALL COMPLY WITH THE FOLLOWING:

- 1. STORE, HANDLE AND DISPOSE OF CONSTRUCTION MATERIALS AND WASTES PROPERLY, SO AS TO PREVENT THEIR CONTACT WITH
- 2. CONTROL AND PREVENT THE DISCHARGE OF ALL POTENTIAL POLLUTANTS, INCLUDING SOLID WASTES, PAINTS, CONCRETE, PETROLEUM PRODUCTS, CHEMICALS, WASHWATER OR SEDIMENTS AND NON-STORMWATER DISCHARGES TO STORM DRAINS AND WATERCOURSES.
- USE SEDIMENT CONTROL OR FILTRATION TO REMOVE SEDIMENT FROM DEWATERING EFFLUENT.
- 4. AVOID CLEANING, FUELING OR MAINTAINING VEHICLES ON-SITE, EXCEPT IN A DESIGNATED AREA IN WHICH RUNOFF IS CONTAINED AND TREATED.
- 5. DELINEATE CLEARING LIMITS, EASEMENTS, SETBACKS, SENSITIVE OR CRITICAL AREAS, BUFFER ZONES, TREES, AND DRAINAGE COURSES WITH FIELD MARKERS.
- 6. PROTECT ADJACENT PROPERTIES AND UNDISTURBED AREAS FROM CONSTRUCTION IMPACTS USING VEGETATIVE BUFFER STRIPS, SEDIMENT BARRIERS OR FILTERS, DIKES, MULCHING, OR OTHER MEASURES AS APPROPRIATE.
- 7. PERFORM CLEARING AND EARTH MOVING ACTIVITIES ONLY DURING DRY WEATHER.
- 8. LIMIT AND TIME APPLICATIONS OF PESTICIDES AND FERTILIZERS TO PREVENT POLLUTED RUNOFF.
- LIMIT CONSTRUCTION ACCESS ROUTES AND STABILIZE DESIGNATED ACCESS POINTS.
- 10. AVOID TRACKING DIRT OR OTHER MATERIALS OFF-SITE PAVED AREAS AND SIDEWALKS USING DRY SWEEPING METHODS.

BASIS OF BEARINGS:

ALL BEARINGS AND DISTANCES DERIVED FROM POINTS SHOWN HEREON ARE BASED UPON THE NORTH AMERICAN DATUM OF 1983

VERTICAL DATUM:

ALL ELEVATIONS SHOWN HEREON ARE BASED UPON THE NORTH AMERICAN VERTICAL DATUM OF 1988 (NAVD88). (GPS FAST STATIC DERIVED)

ABBREVIATIONS:

<u>SYMBOL</u>	<u>DESCRIPTION</u>
Q	CENTERLINE
ø	DIAMETER
#	NUMBER
6 " T	6" DIAMETER TREE
AC	ASPHALTIC CONCRETE
ALT	ALTERNATE
APPROX	APPROXIMATE
BC	BEGINNING OF CURVE
BLDG	BUILDING
BW	BACK OF WALK
СВ	CATCH BASIN
CONC	CONCRETE
CP	CONCRETE PAD
CY	CUBIC YARD
DBL	DOUBLE
DI	DISTANCE
DW, D/W, DWY	DRIVEWAY
E, ELEC	ELECTRIC
(E), EX, EXIST	EXISTING
EASE	EASEMENT
EC	END OF CURVE
EG CLCV	EXISTING GROUND
EL, ELEV EP	ELEVATION EDGE OF PAVEMENT
ETW	EDGE OF TRAVELWAY
FC	FACE OF CURB
FG	FINISH GRADE
FH	FIRE HYDRANT
FL	FLOW LINE
FT	FEET, FOOT
HC/HCR	ACCESSIBILITY RAMP
HWY	HIGHWAY
INV	INVERT
JT	JOINT TRENCH
LF	LINEAR FOOT

LIP OF GUTTER

C 48056 **EXPIRES** 12/31/17

APPROVED:

JAMES C. PORTER, DIRECTOR OF PUBLIC WORKS R. C. E. # 48056 / EXPIRES 12-31-2017 DESCRIPTION

STMBOL	DESCRIPTION
LT LOL LP MAX MIN MH MON (N) NO. NT NTS OH, O/H	LEFT LAYOUT LINE LOW POINT MAXIMUM MINIMUM MANHOLE MONUMENT NEW NUMBER NO TAG NOT TO SCALE OVERHEAD
PCC PL, P/L PR, PROP RCP RIM RT R/W, R.O.W. RW SD SDMH SL SS SSCO SSMH STA STD SQFT. TC T, TEL	PORTLAND CEMENT CONCRETE PROPERTY LINE PROPOSED REINFORCED CONCRETE PIPE RIM ELEVATION RIGHT RIGHT OF WAY RETAINING WALL STORM DRAIN STORM DRAIN MANHOLE STREETLIGHT SANITARY SEWER SANITARY SEWER CLEANOUT SANITARY SEWER MANHOLE STATION STANDARD SQUARE FEET TOP OF CURB TELEPHONE
TRANS TS TW TYP W	TRANSFORMER TRAFFIC SIGNAL TOP OF WALL TYPICAL WATER

LEGEND:

	PROPOSED	<u>EXISTING</u>
BOUNDARY		
STORM DRAIN LINE	12" SD	SD
SANITARY SEWER LINE	6" SS	ss
WATER LINE	8"W	W
MANHOLE	•	
FIRE HYDRANT		₩.
BLOW OFF	•	ď
VALVE	•	•
CURB INLET		
SPOT ELEVATION	×101	×101
TRANSFORMER	T	
ELECTRICAL	———Е——	———Е——
JOINT TRENCH	JT	JT
OVERHEAD TELEPHONE	———ОН———	OH
GAS	G	G
SWALE	··	··-
ELECTROLIER	\$	\$
TRAFFIC SIGNAL	¤	\$
TRAFFIC SIGN	-	-
FENCE	xxxxx	xxxxx
TREE		
TREE DEMO	×	



SCALE: AS SHOWN

DATE: 5/20/16

FILE NO.: 1/XXX


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30% SUBMITTAL - FOR REVIEW ONLY

APPROVED DATE: JASON MANSFIELD, PROJECT MANAGER BKF ENGINEERS R.C.E. # 59567 / EXPIRES 12-31-2017



(650) 482-6300

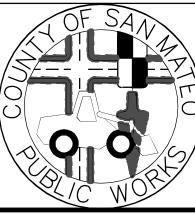



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DESIGNED BY: CT MIDCOAST MULTI-MODAL TRAIL CHECKED BY: JM NOTES, ABBREVIATIONS, & LEGEND DRAWN BY: FC 555 COUNTY CENTER, 5th FLOOR JAMES C. PORTER, DIRECTOR OF PUBLIC WORKS SAN MATEO COUNTY REDWOOD CITY, CALIFORNIA 94063

FOR REDUCED PLANS SHEET 2 OF 24 ORIGINAL SCALE IS IN INCHES



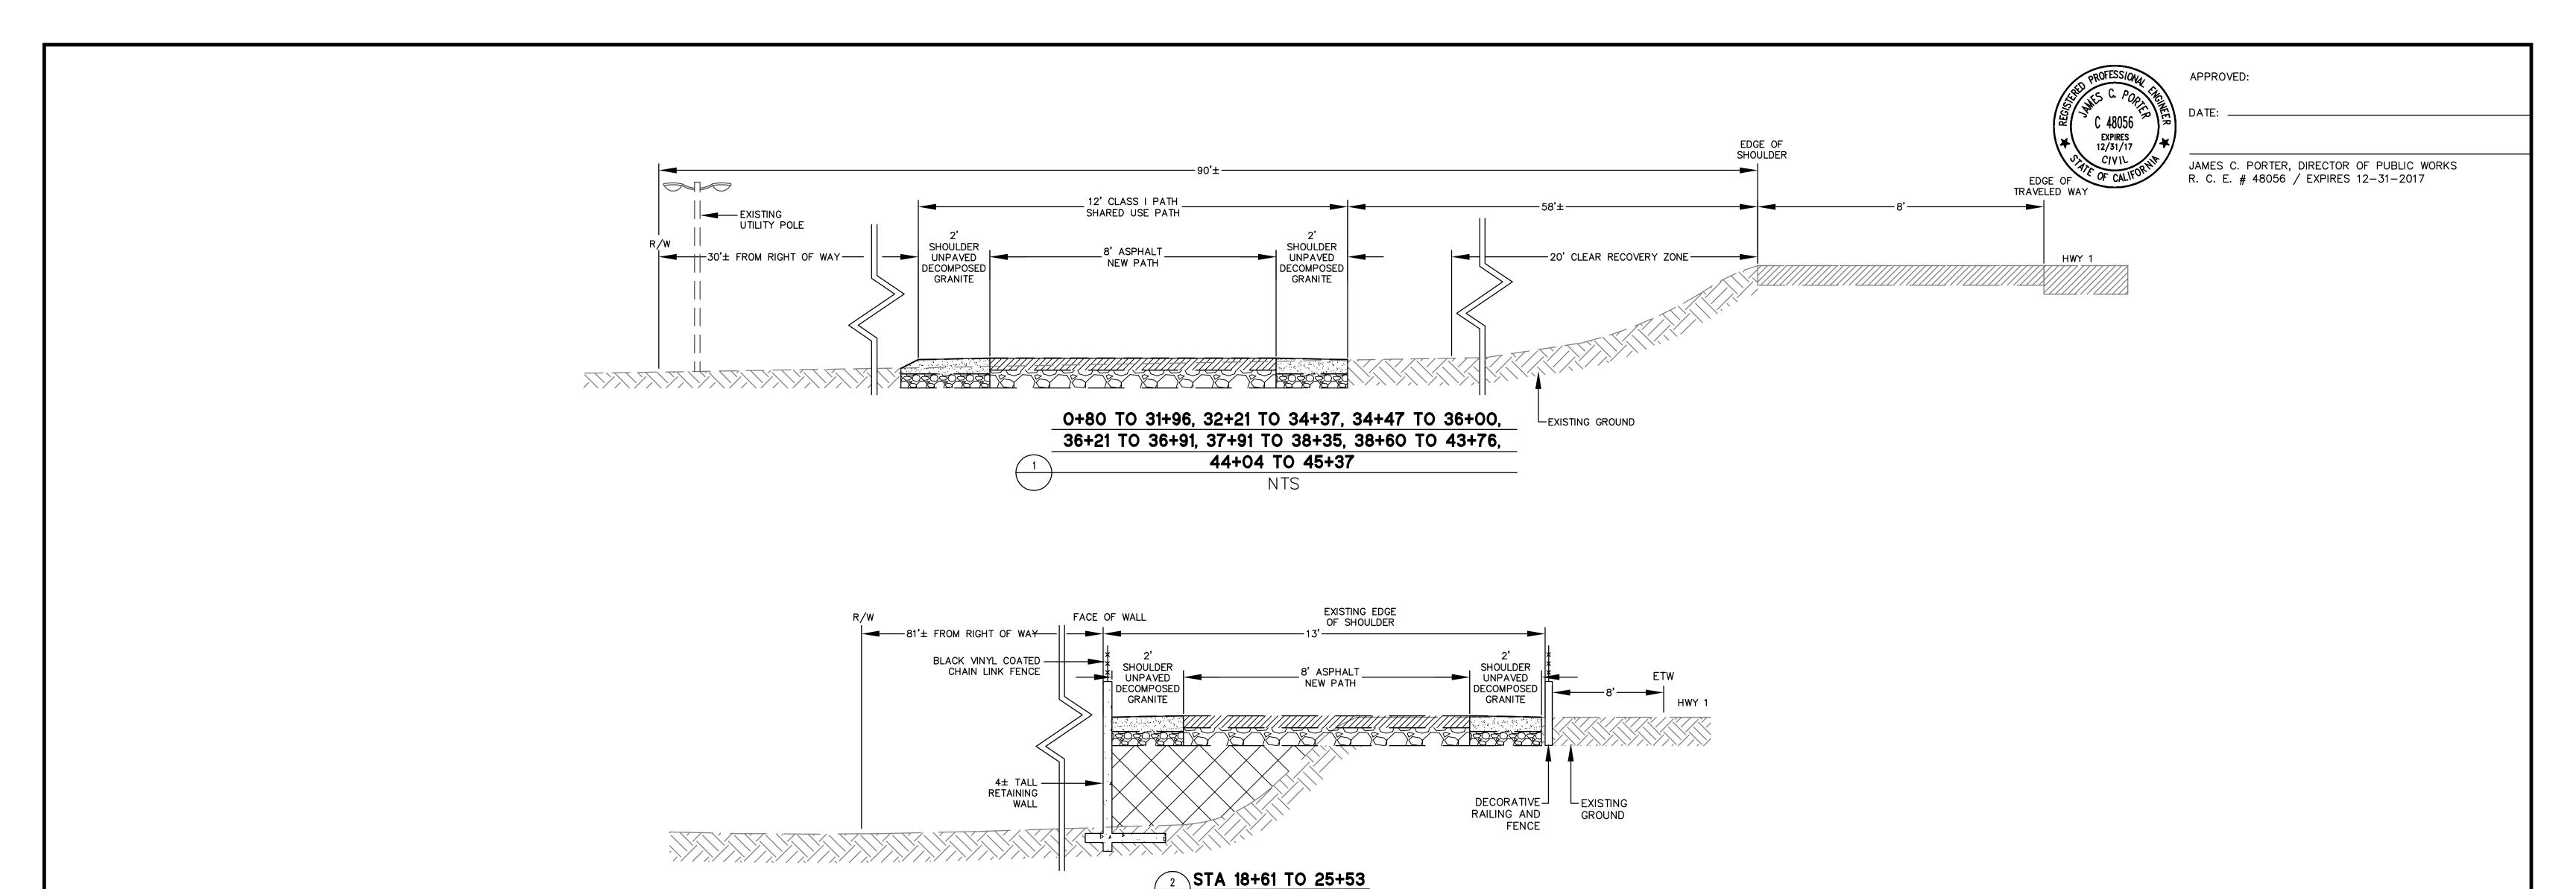

3 STA 36+91 TO 37+91

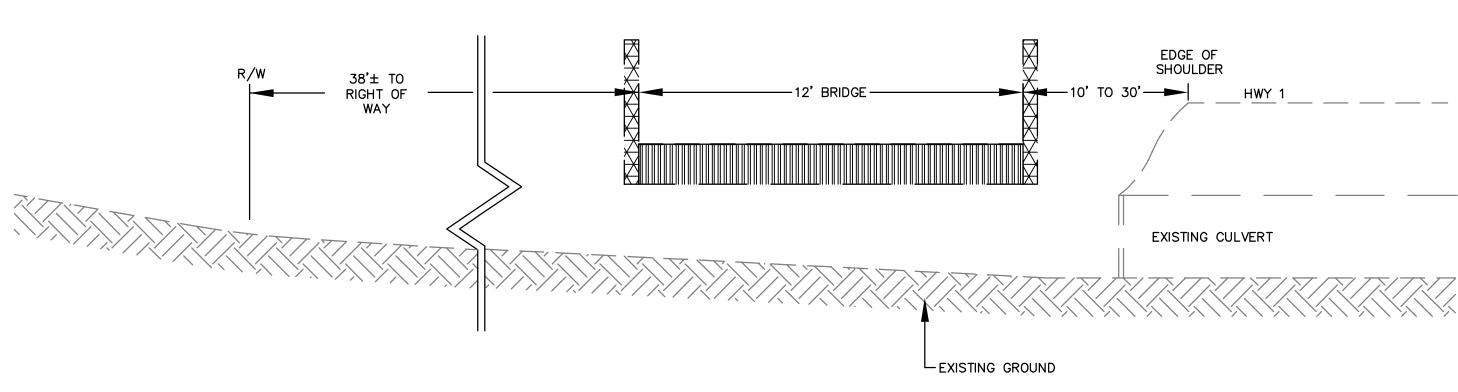30% SUBMITTAL - FOR REVIEW ONLY

SCALE: NTS

APPROVED DATE:	
JASON MANSFIELD, PROJECT MANAGER	1
BKF ENGINEERS	1
R.C.E. # 59567 / EXPIRES 12-31-2017	

BKF	OF SAAVA
Engineers / Surveyors / Planners	O
255 SHORELINE DRIVE, SUITE 200 REDWOOD CITY, CA 94065 (650) 482-6300	900


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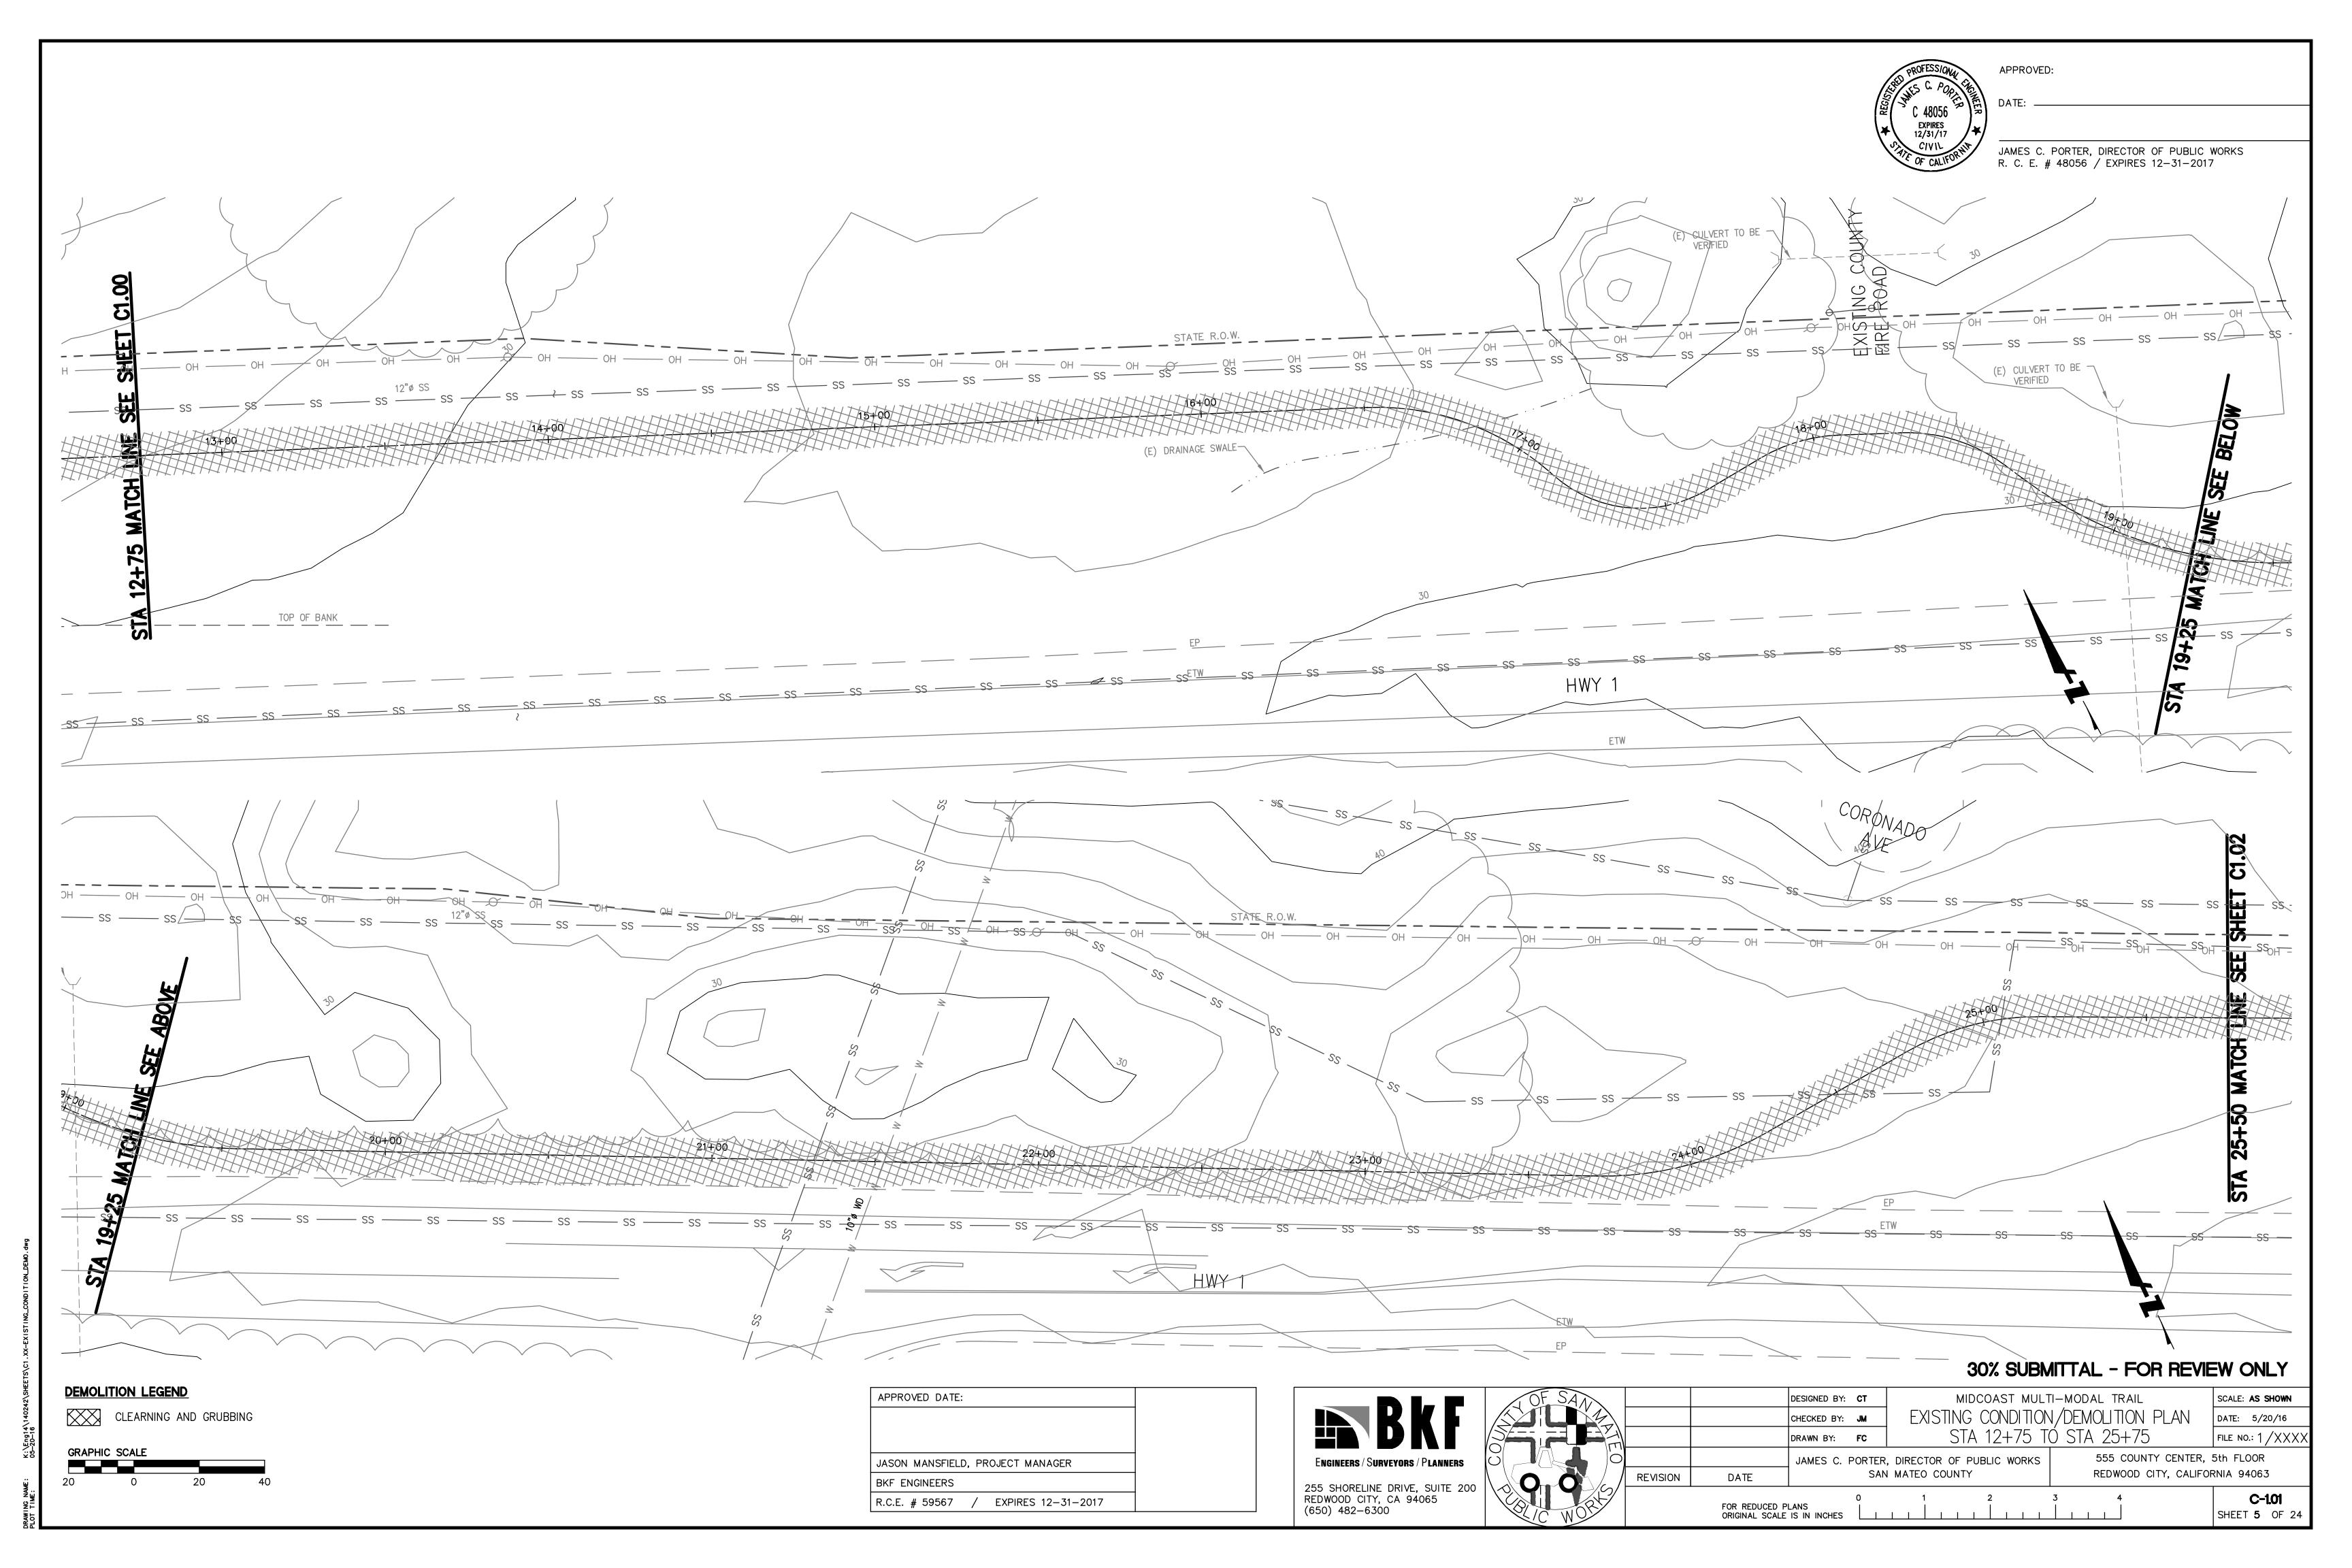
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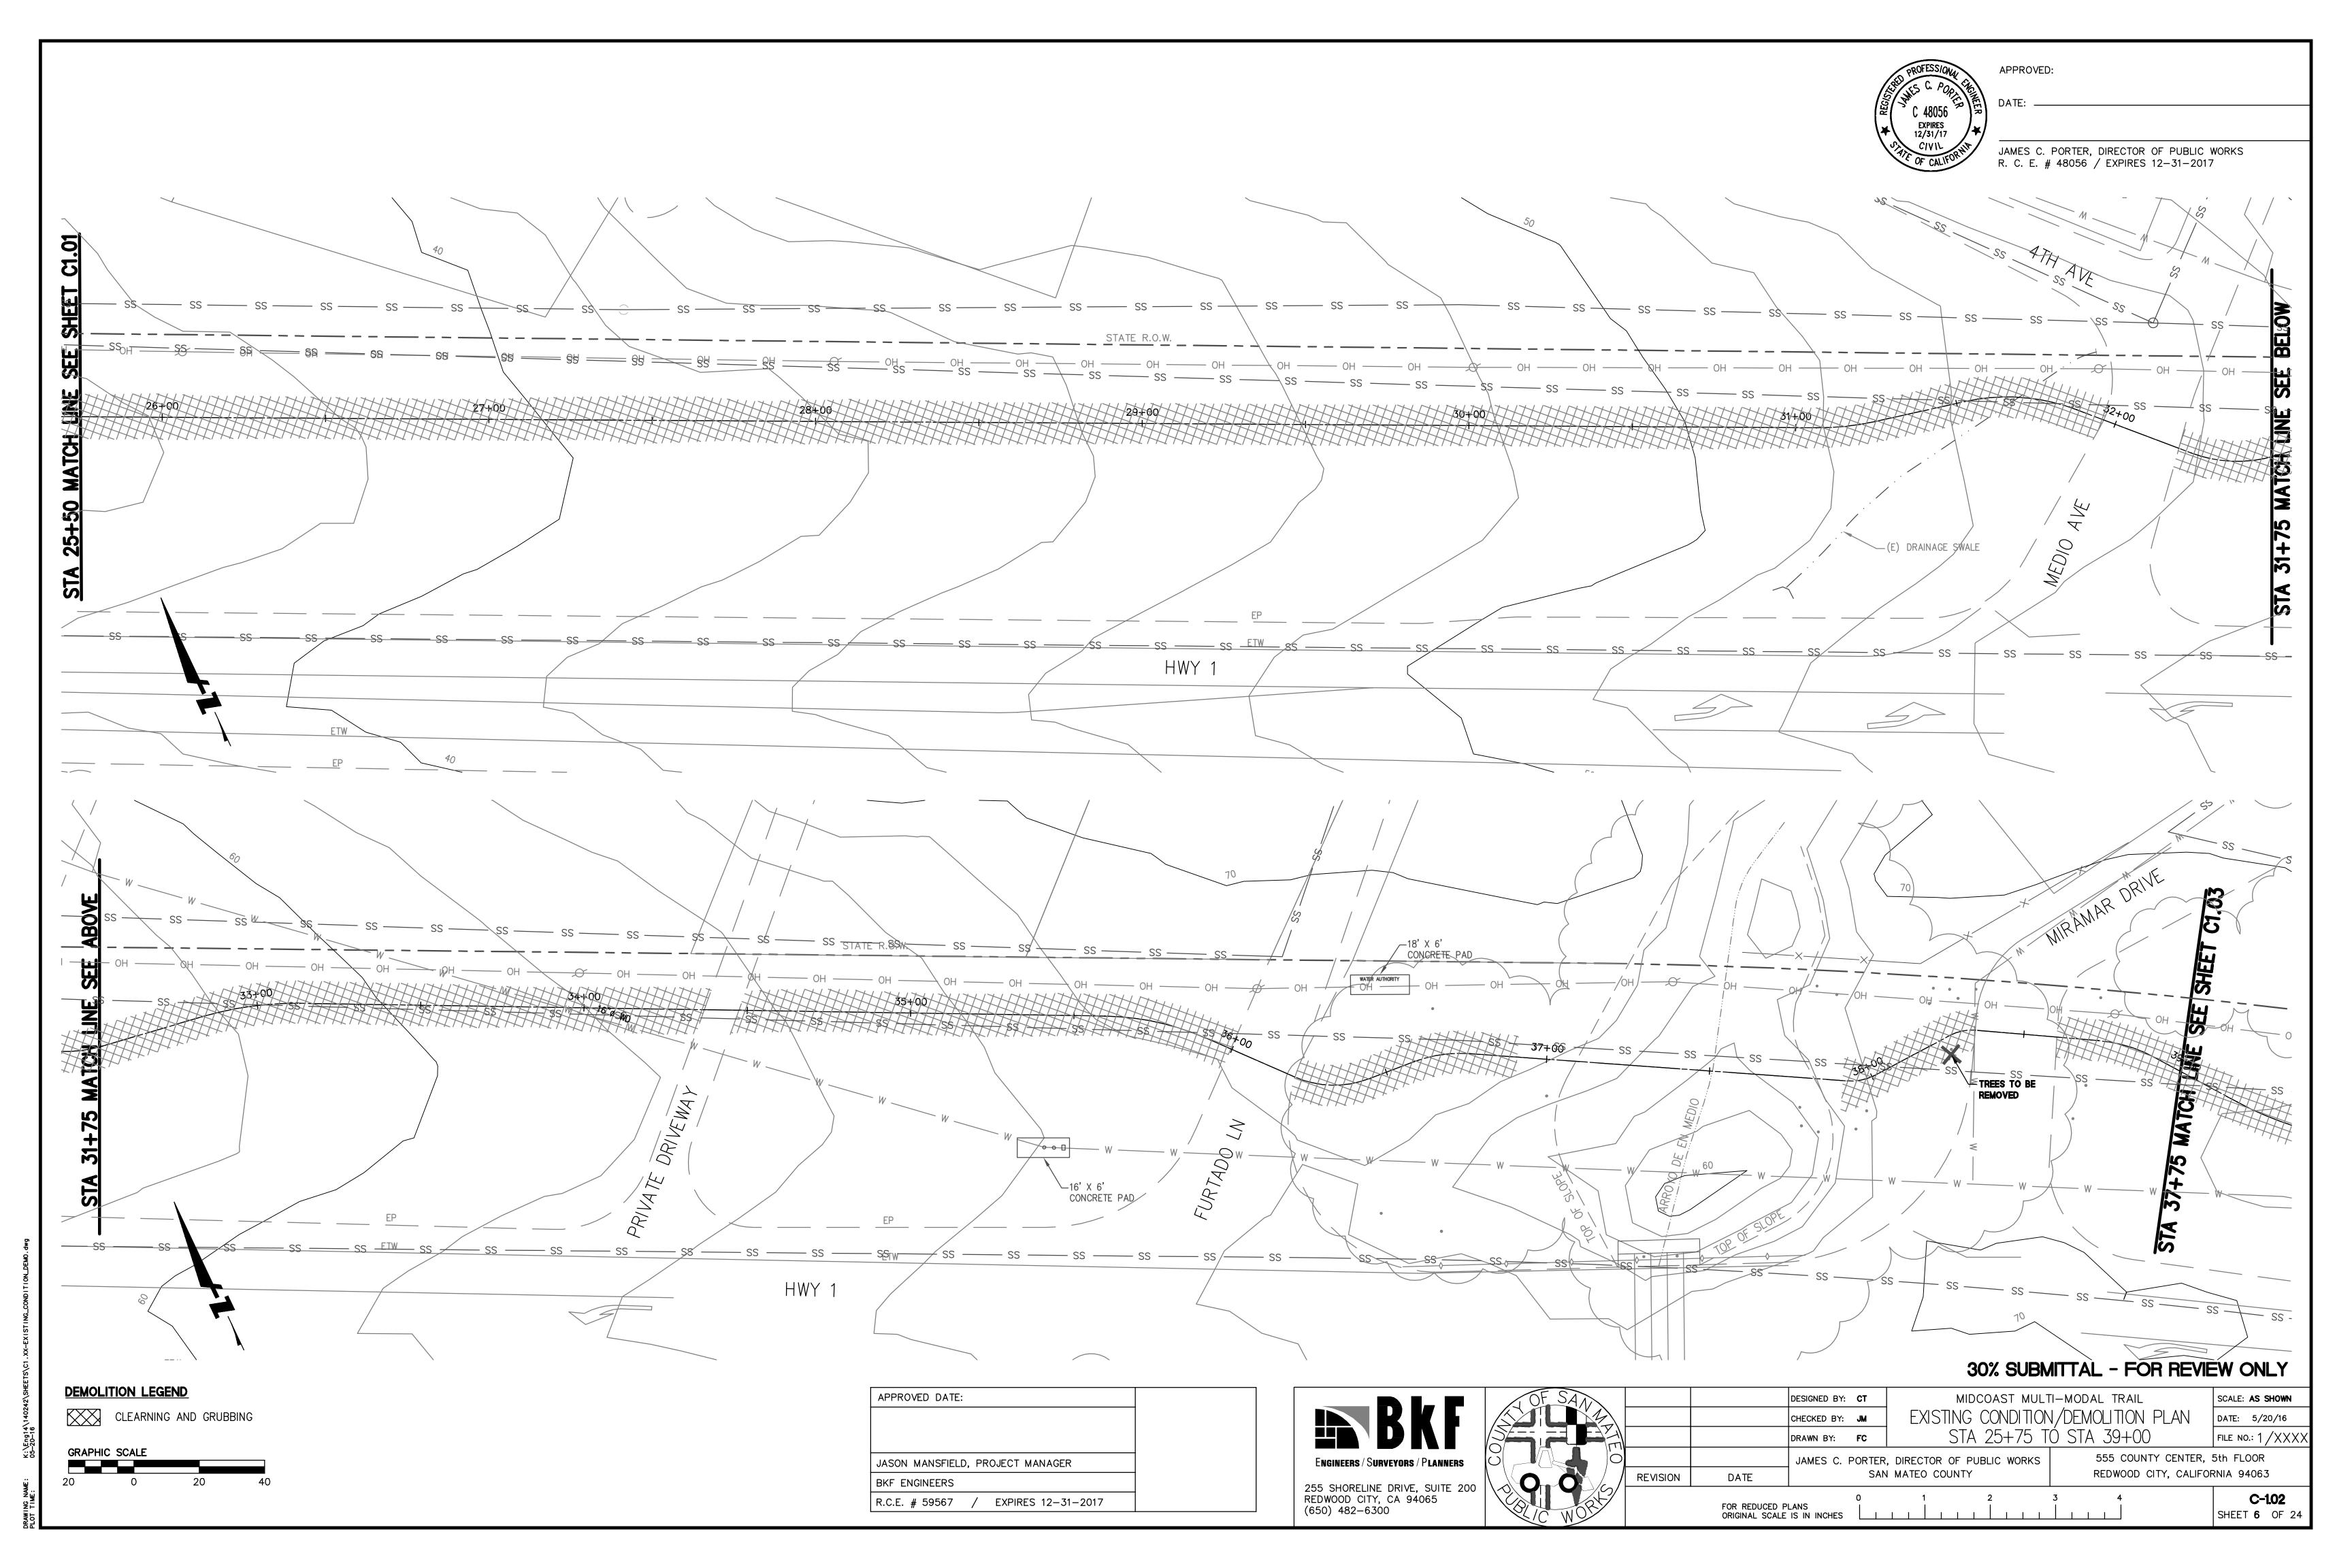
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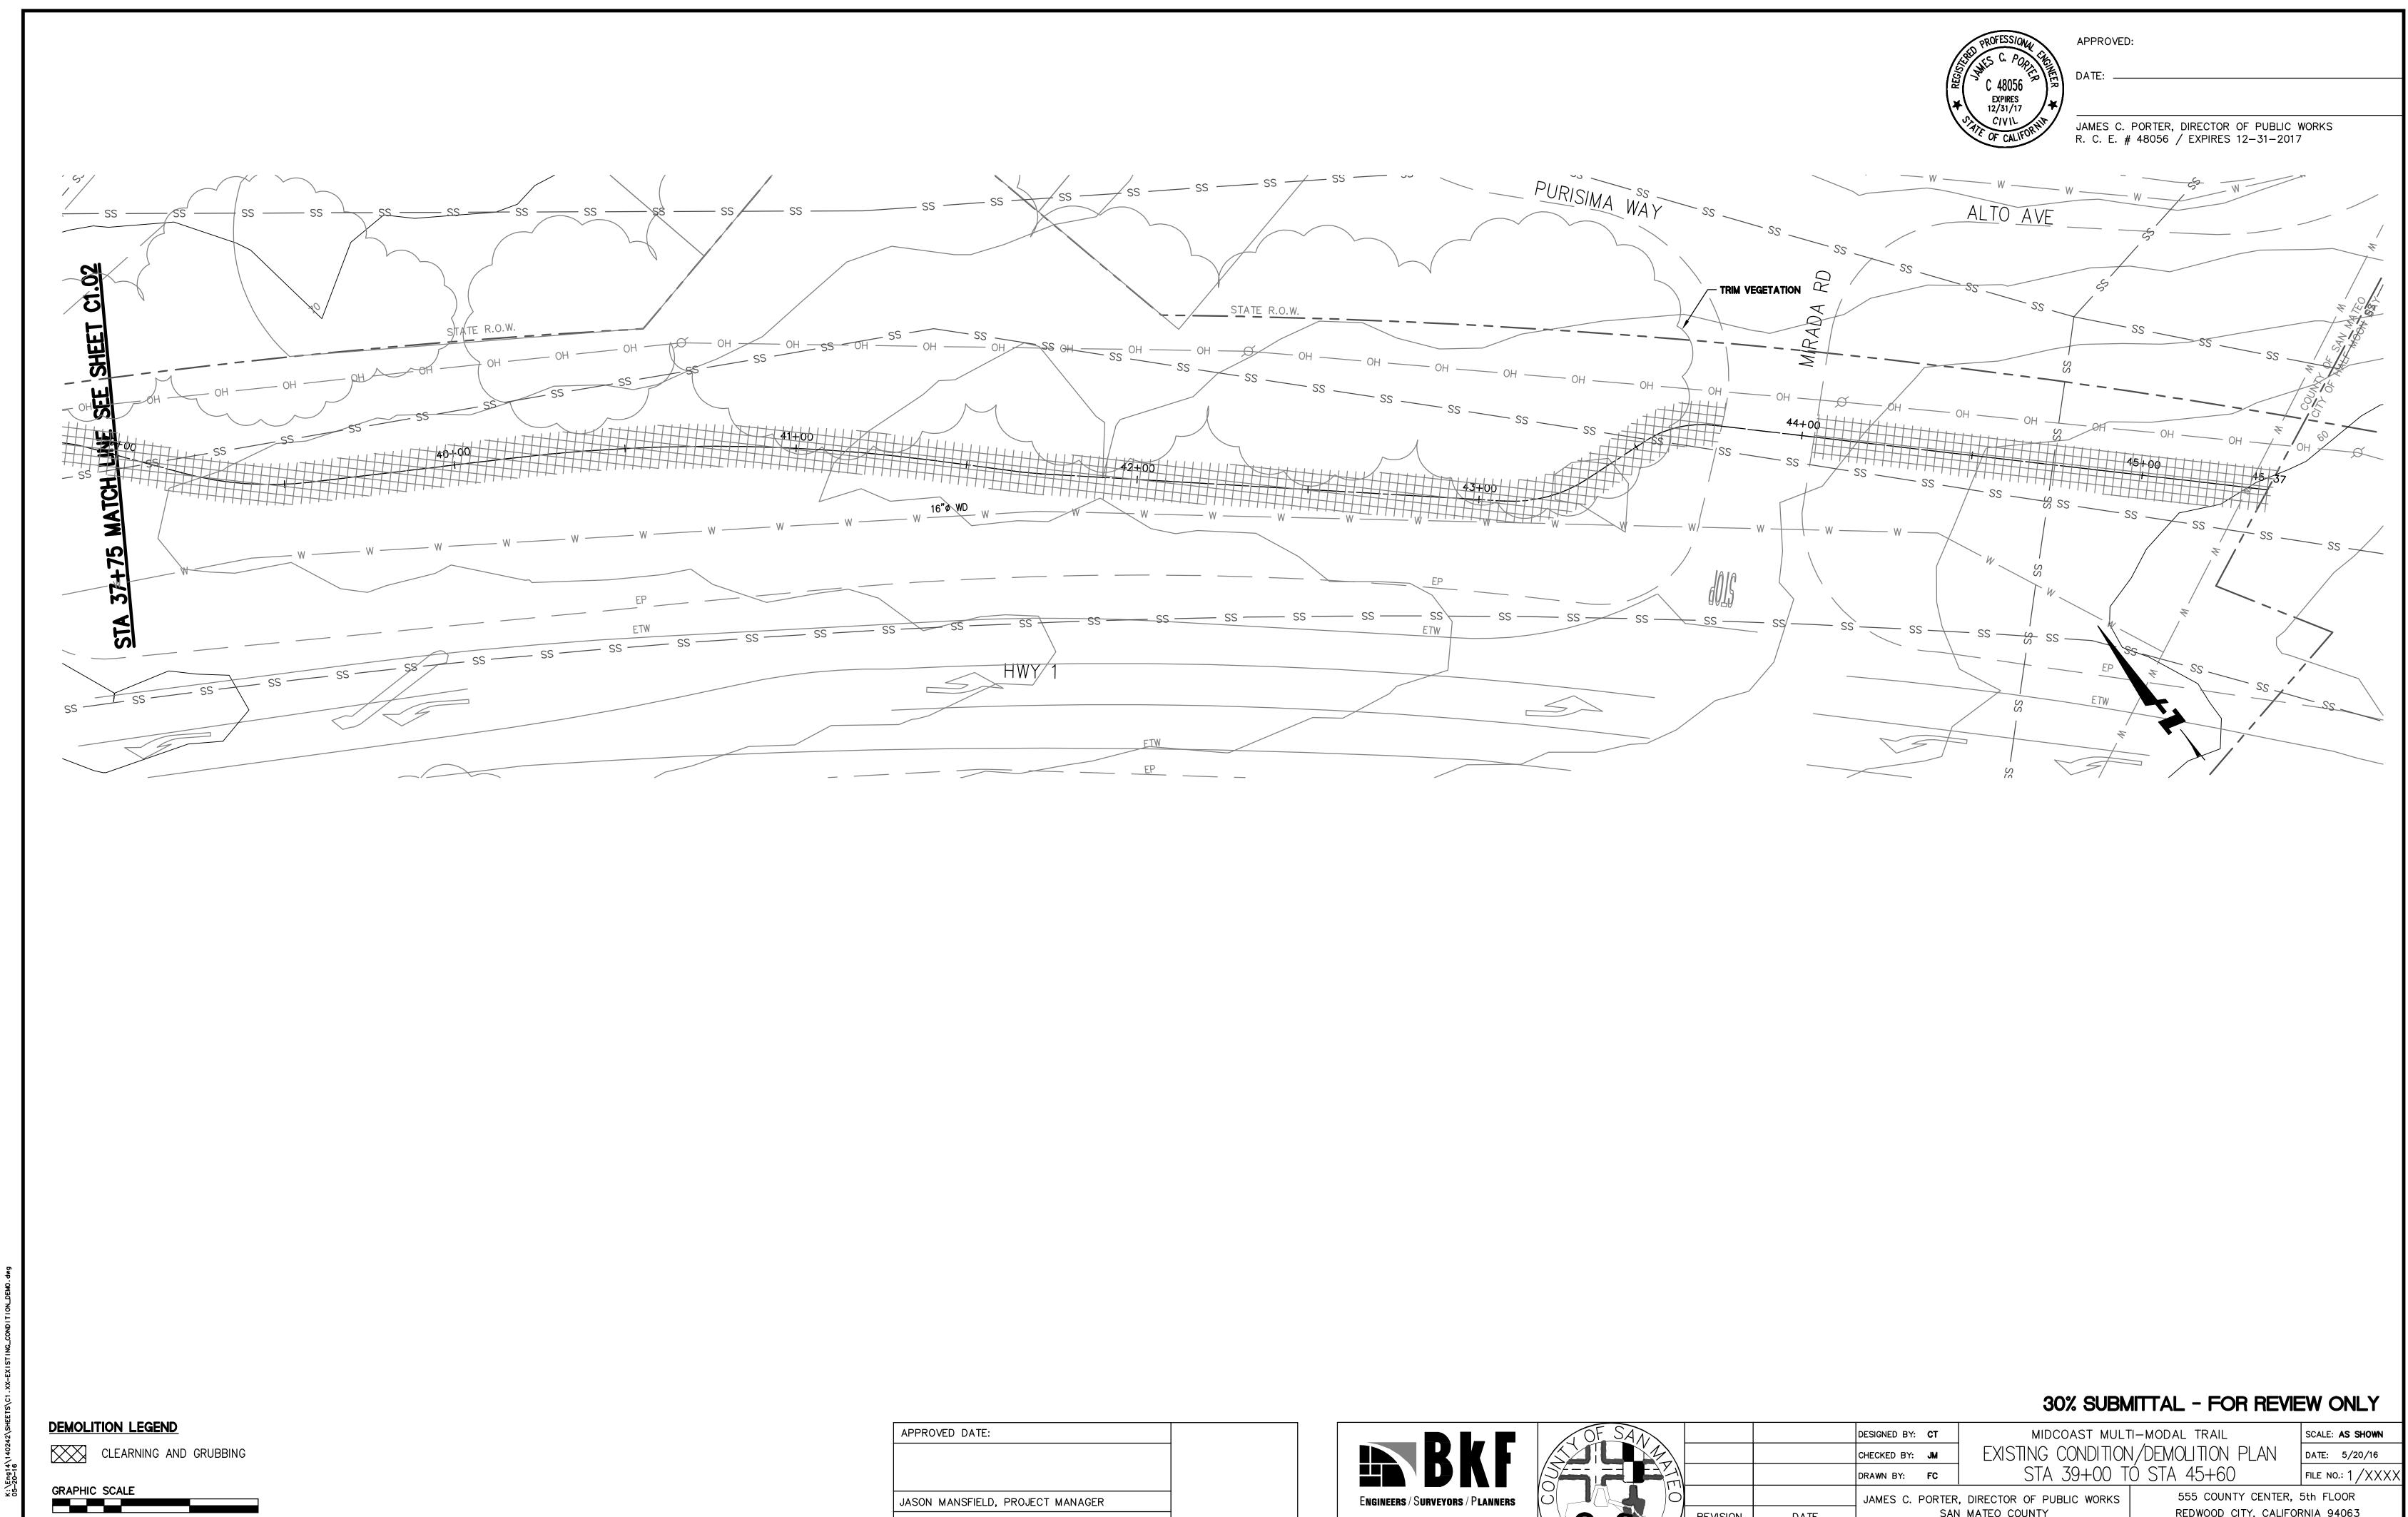
MIDCOAST MULTI-MODAL TRAIL DATE: 5/20/16 TYPICAL CROSS SECTIONS FILE NO.: 1/XXXX

555 COUNTY CENTER, 5th FLOOR , DIRECTOR OF PUBLIC WORKS REDWOOD CITY, CALIFORNIA 94063 SAN MATEO COUNTY REVISION DATE C-0.02 FOR REDUCED PLANS ORIGINAL SCALE IS IN INCHES SHEET **3** OF 24







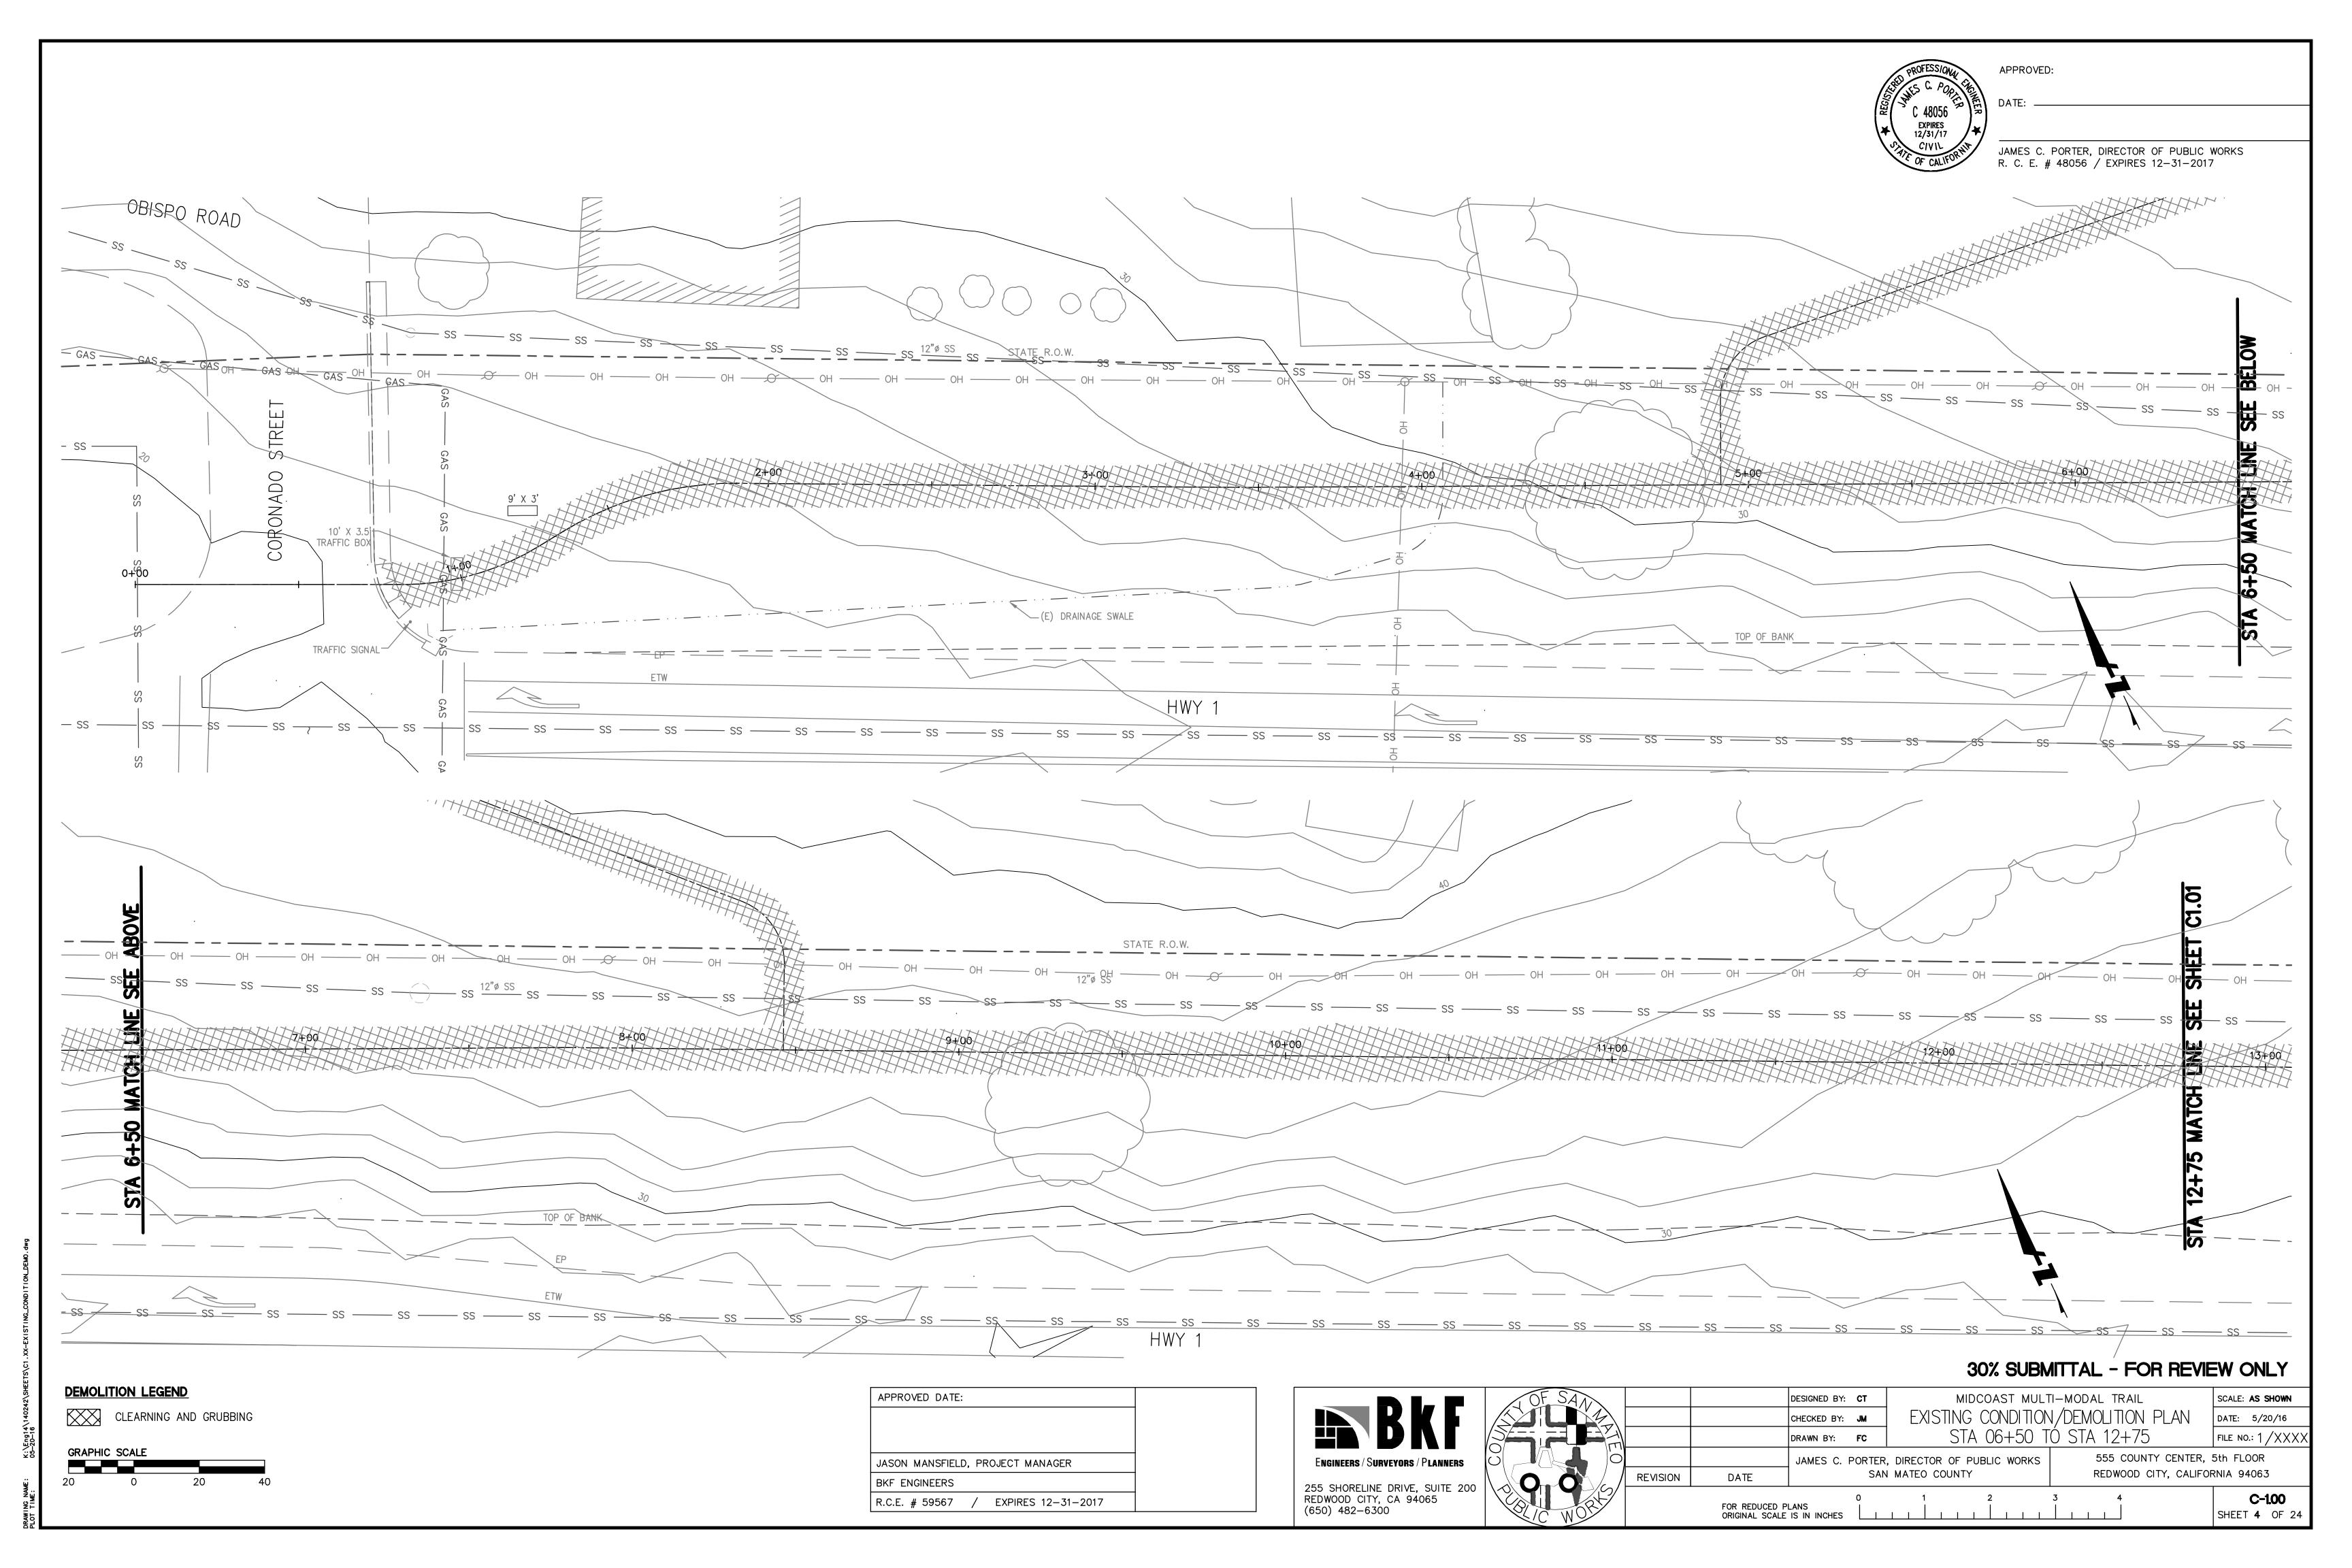

BKF ENGINEERS

R.C.E. # 59567 / EXPIRES 12-31-2017

REDWOOD CITY, CALIFORNIA 94063

C-1.03

SHEET **7** OF 24


SAN MATEO COUNTY


FOR REDUCED PLANS
ORIGINAL SCALE IS IN INCHES


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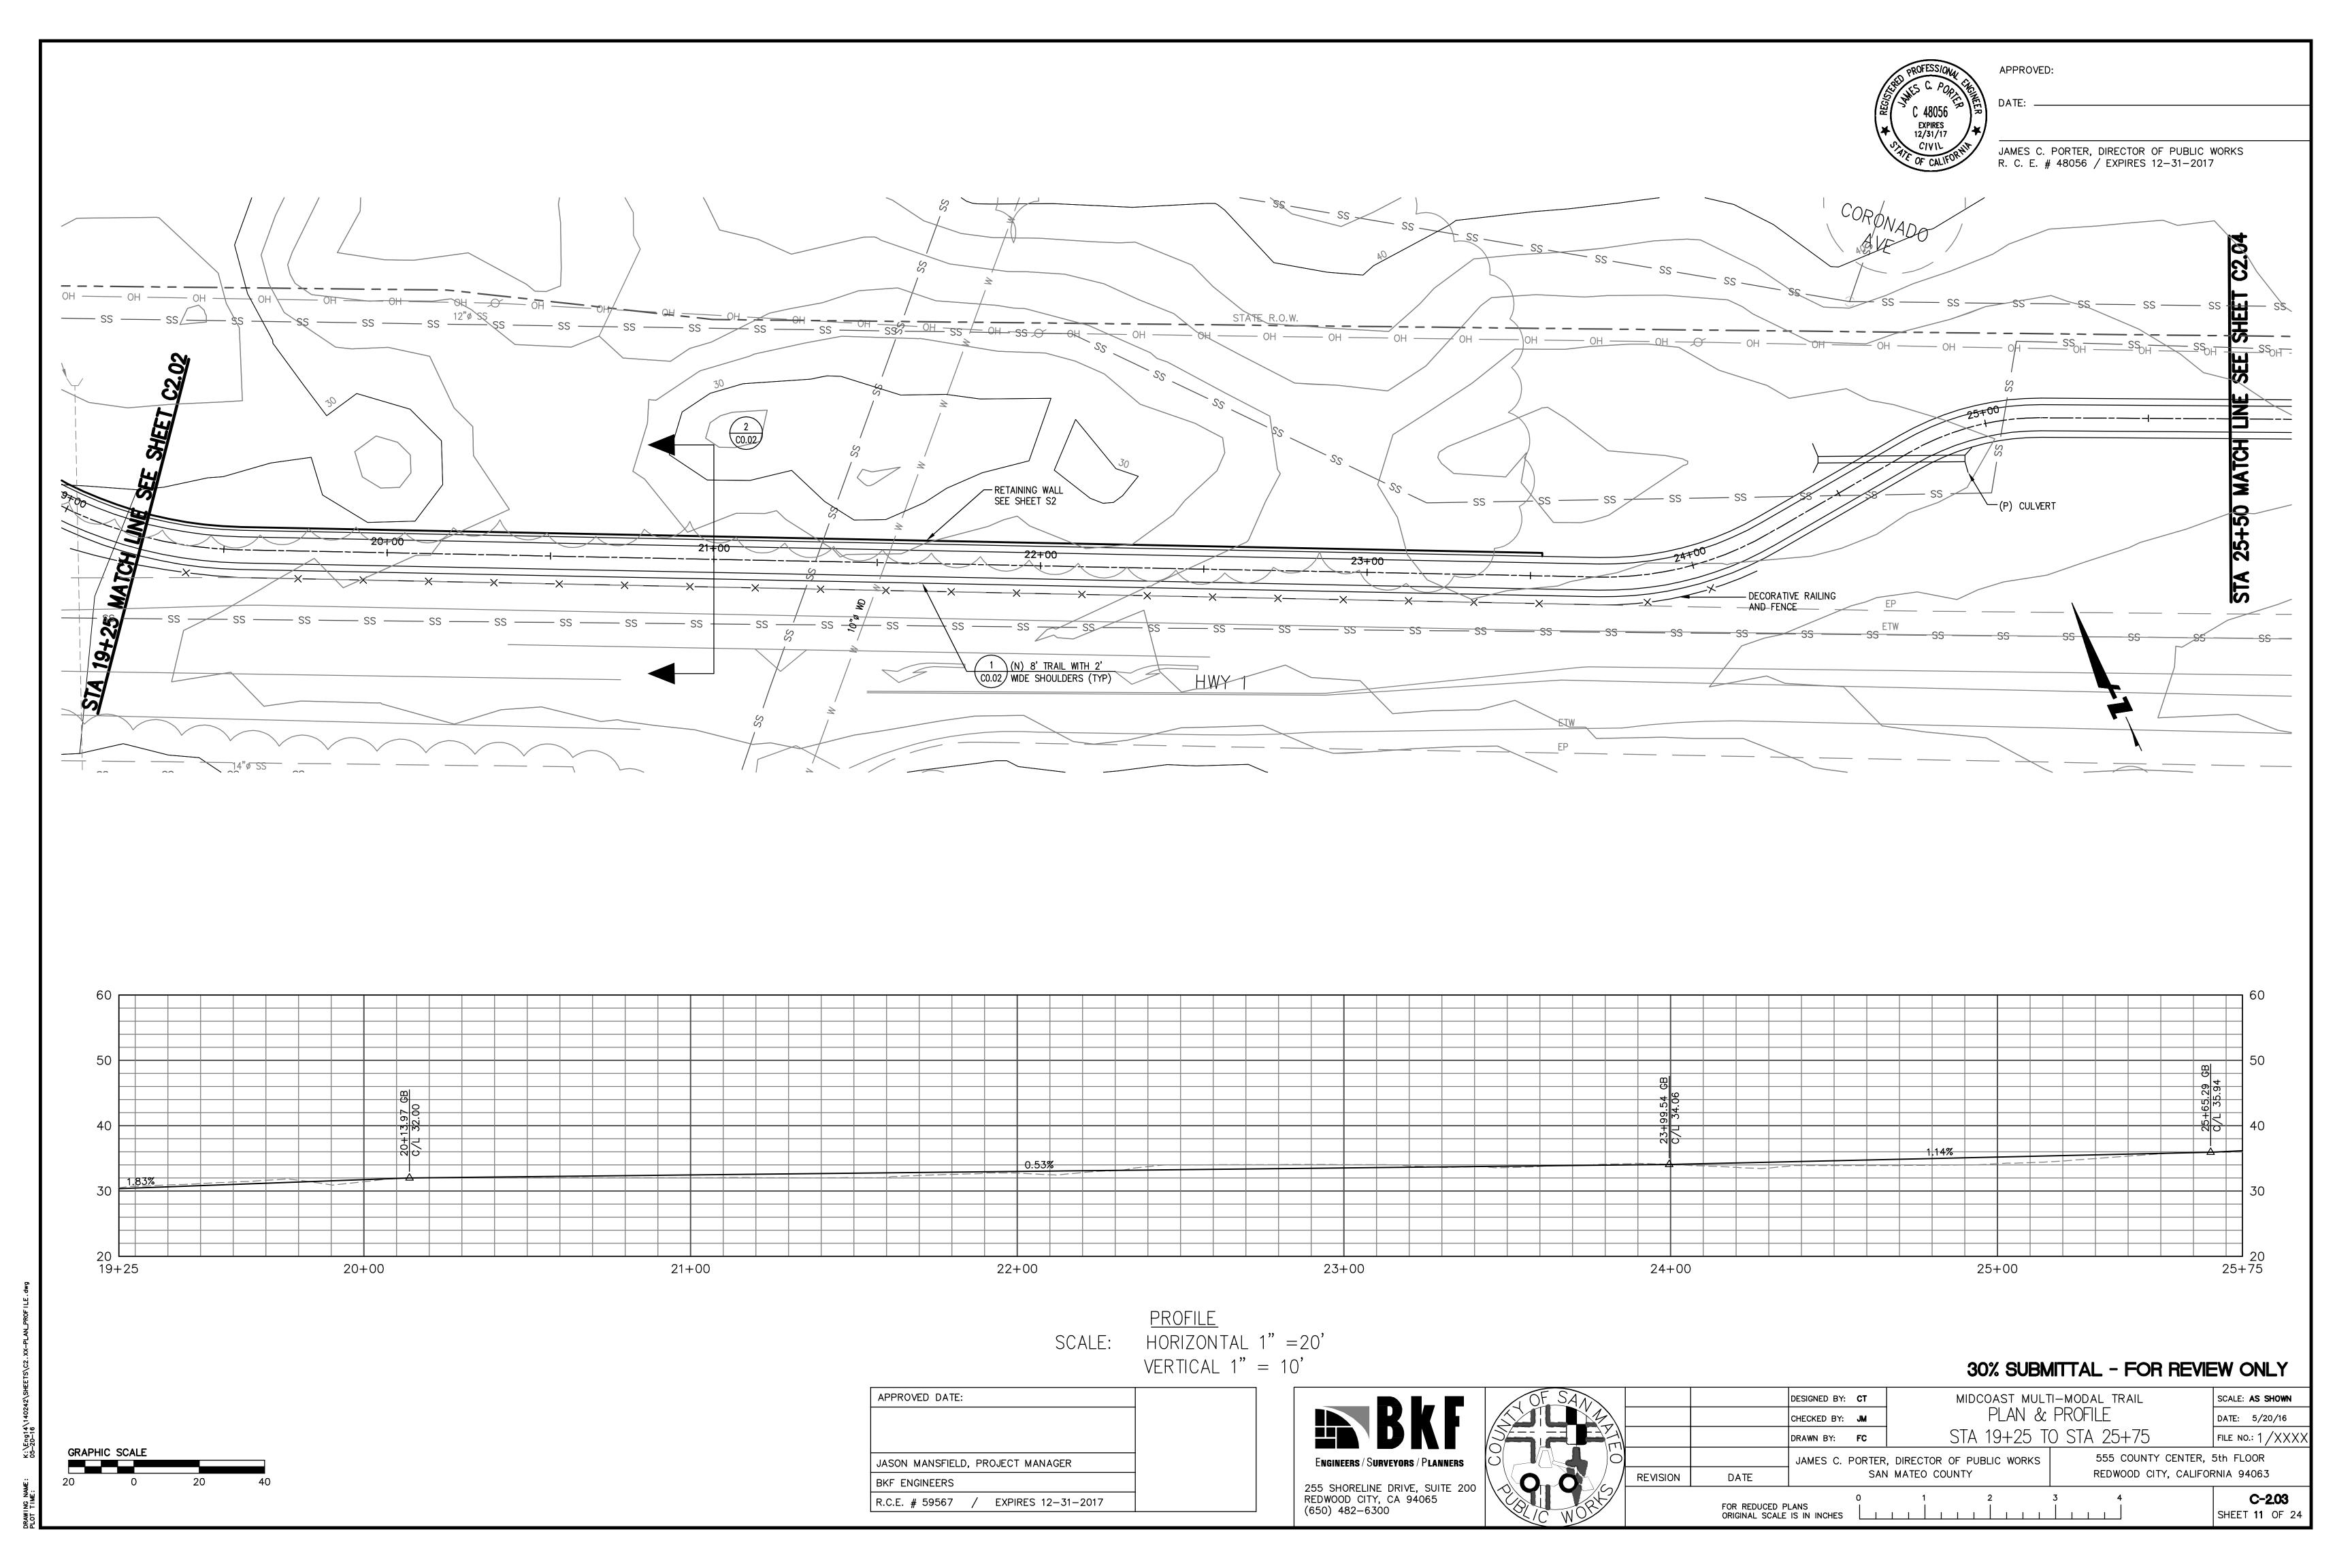
255 SHORELINE DRIVE, SUITE 200 REDWOOD CITY, CA 94065 (650) 482-6300


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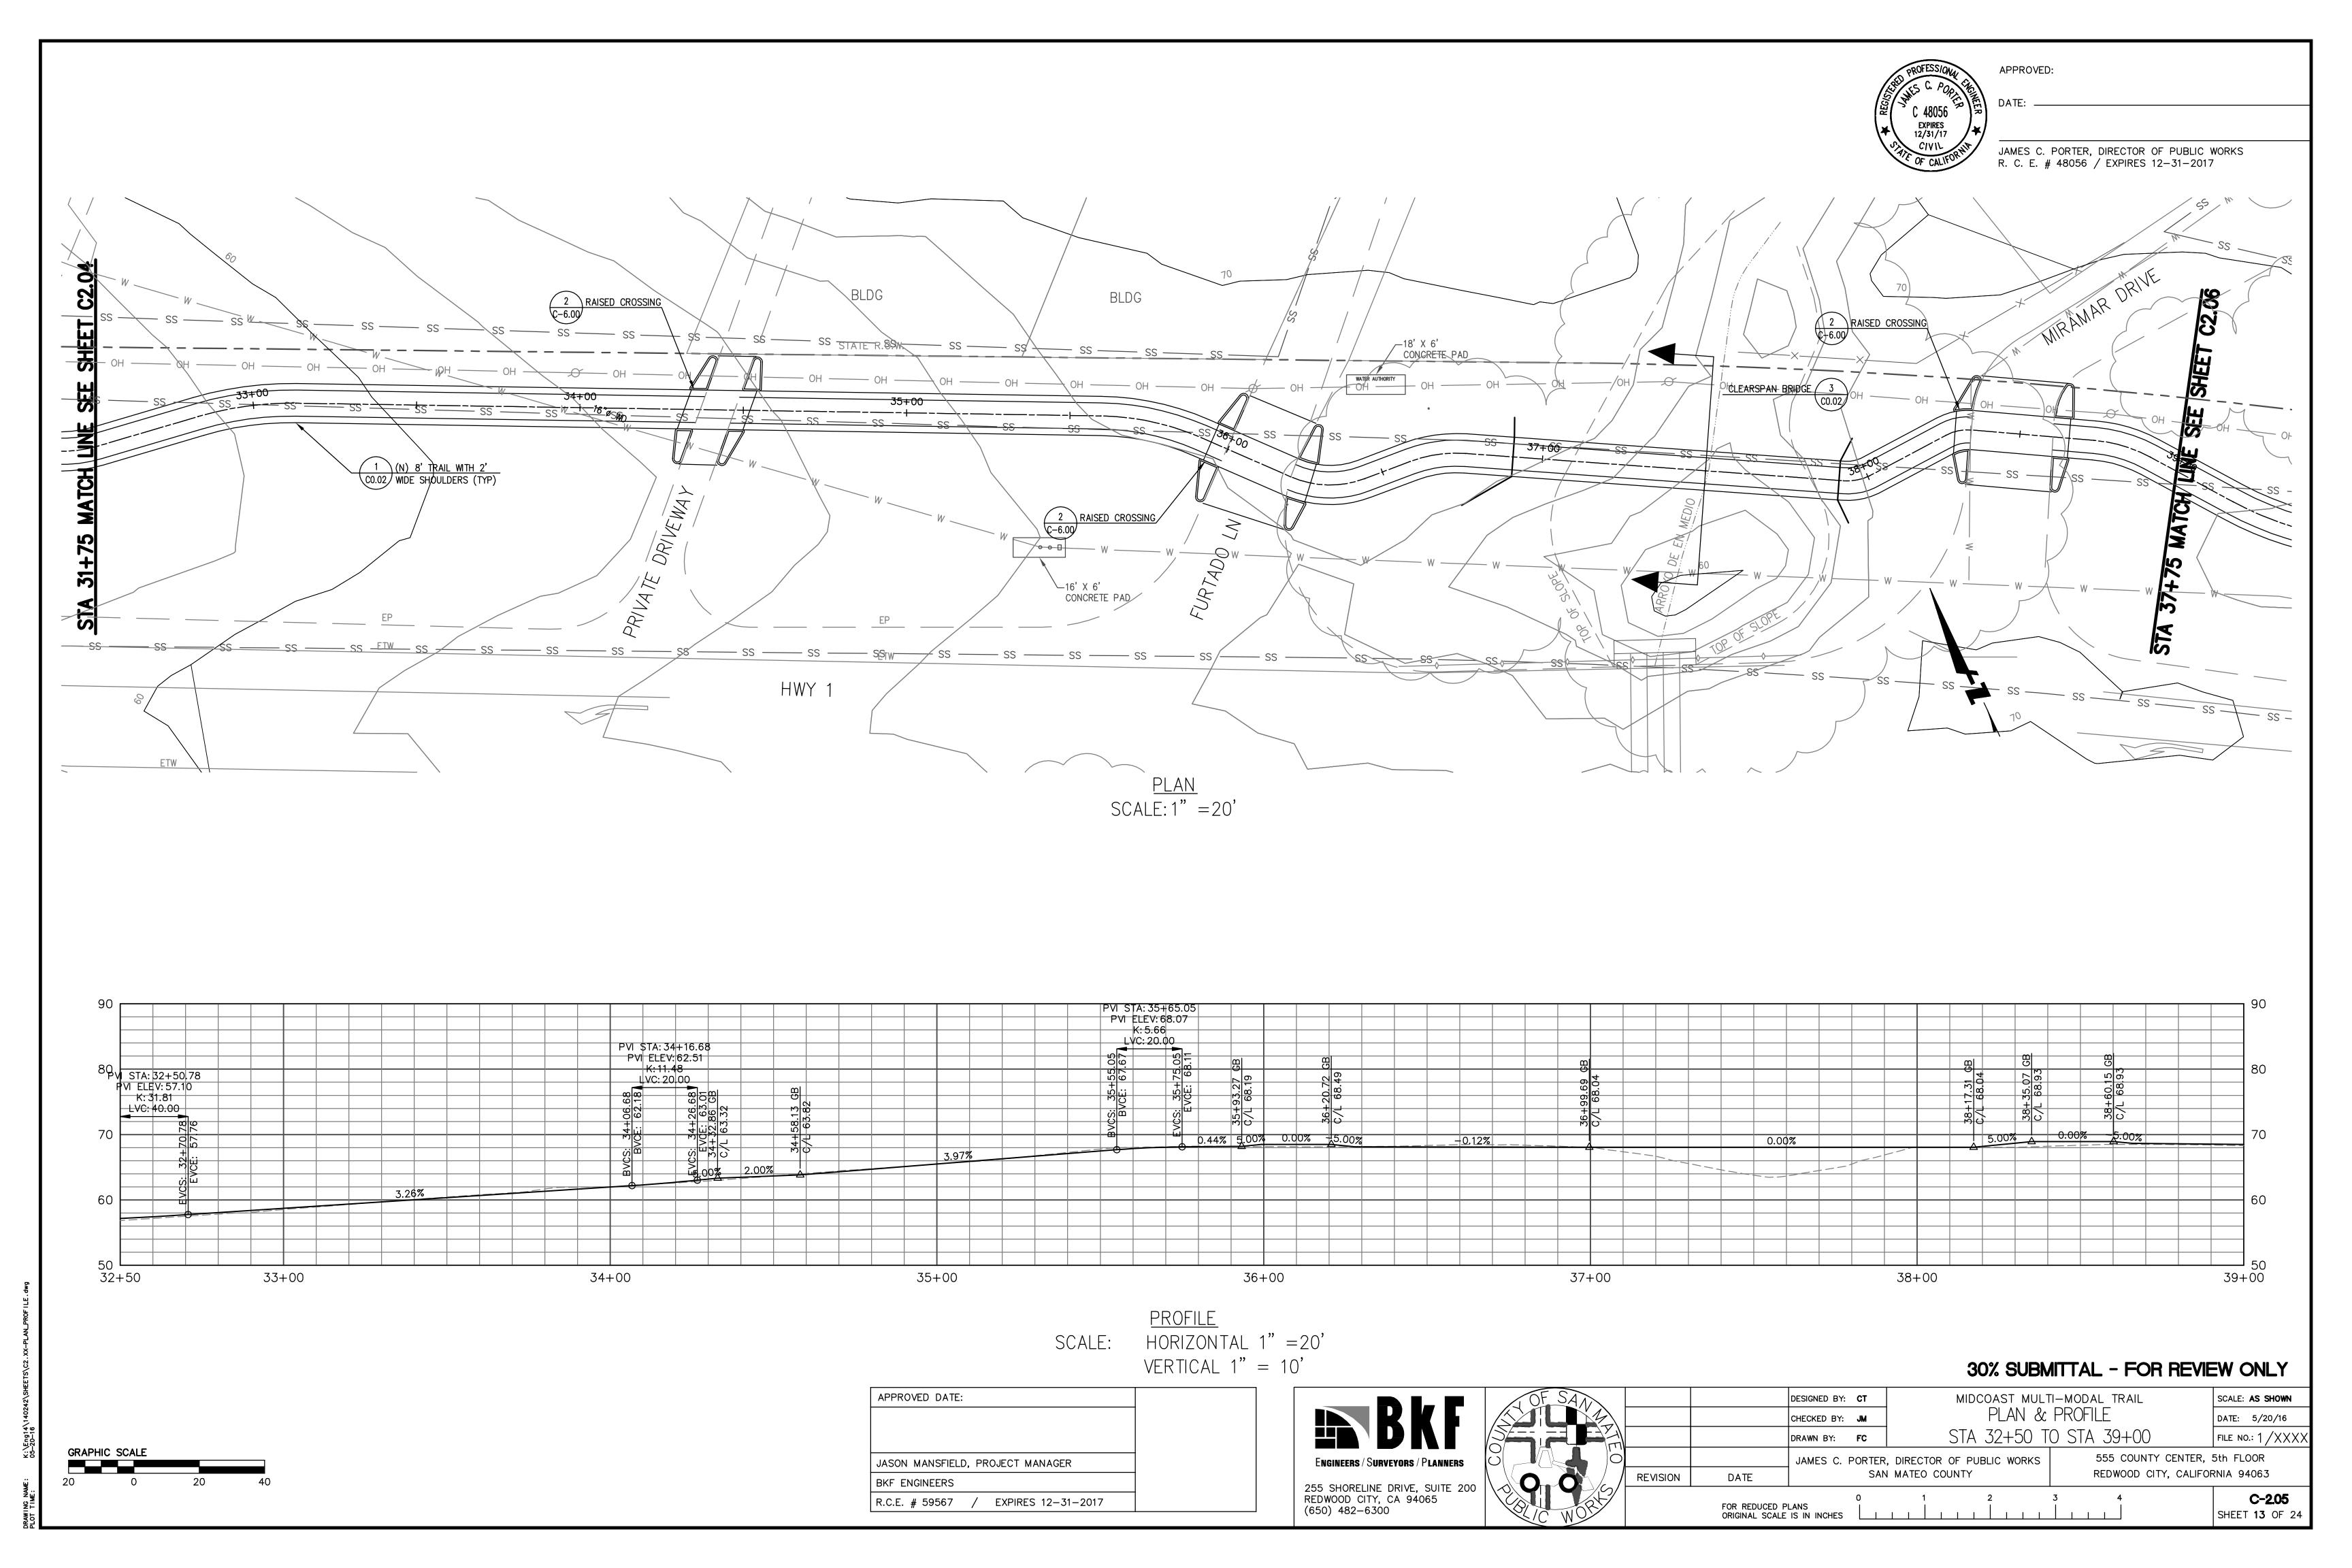





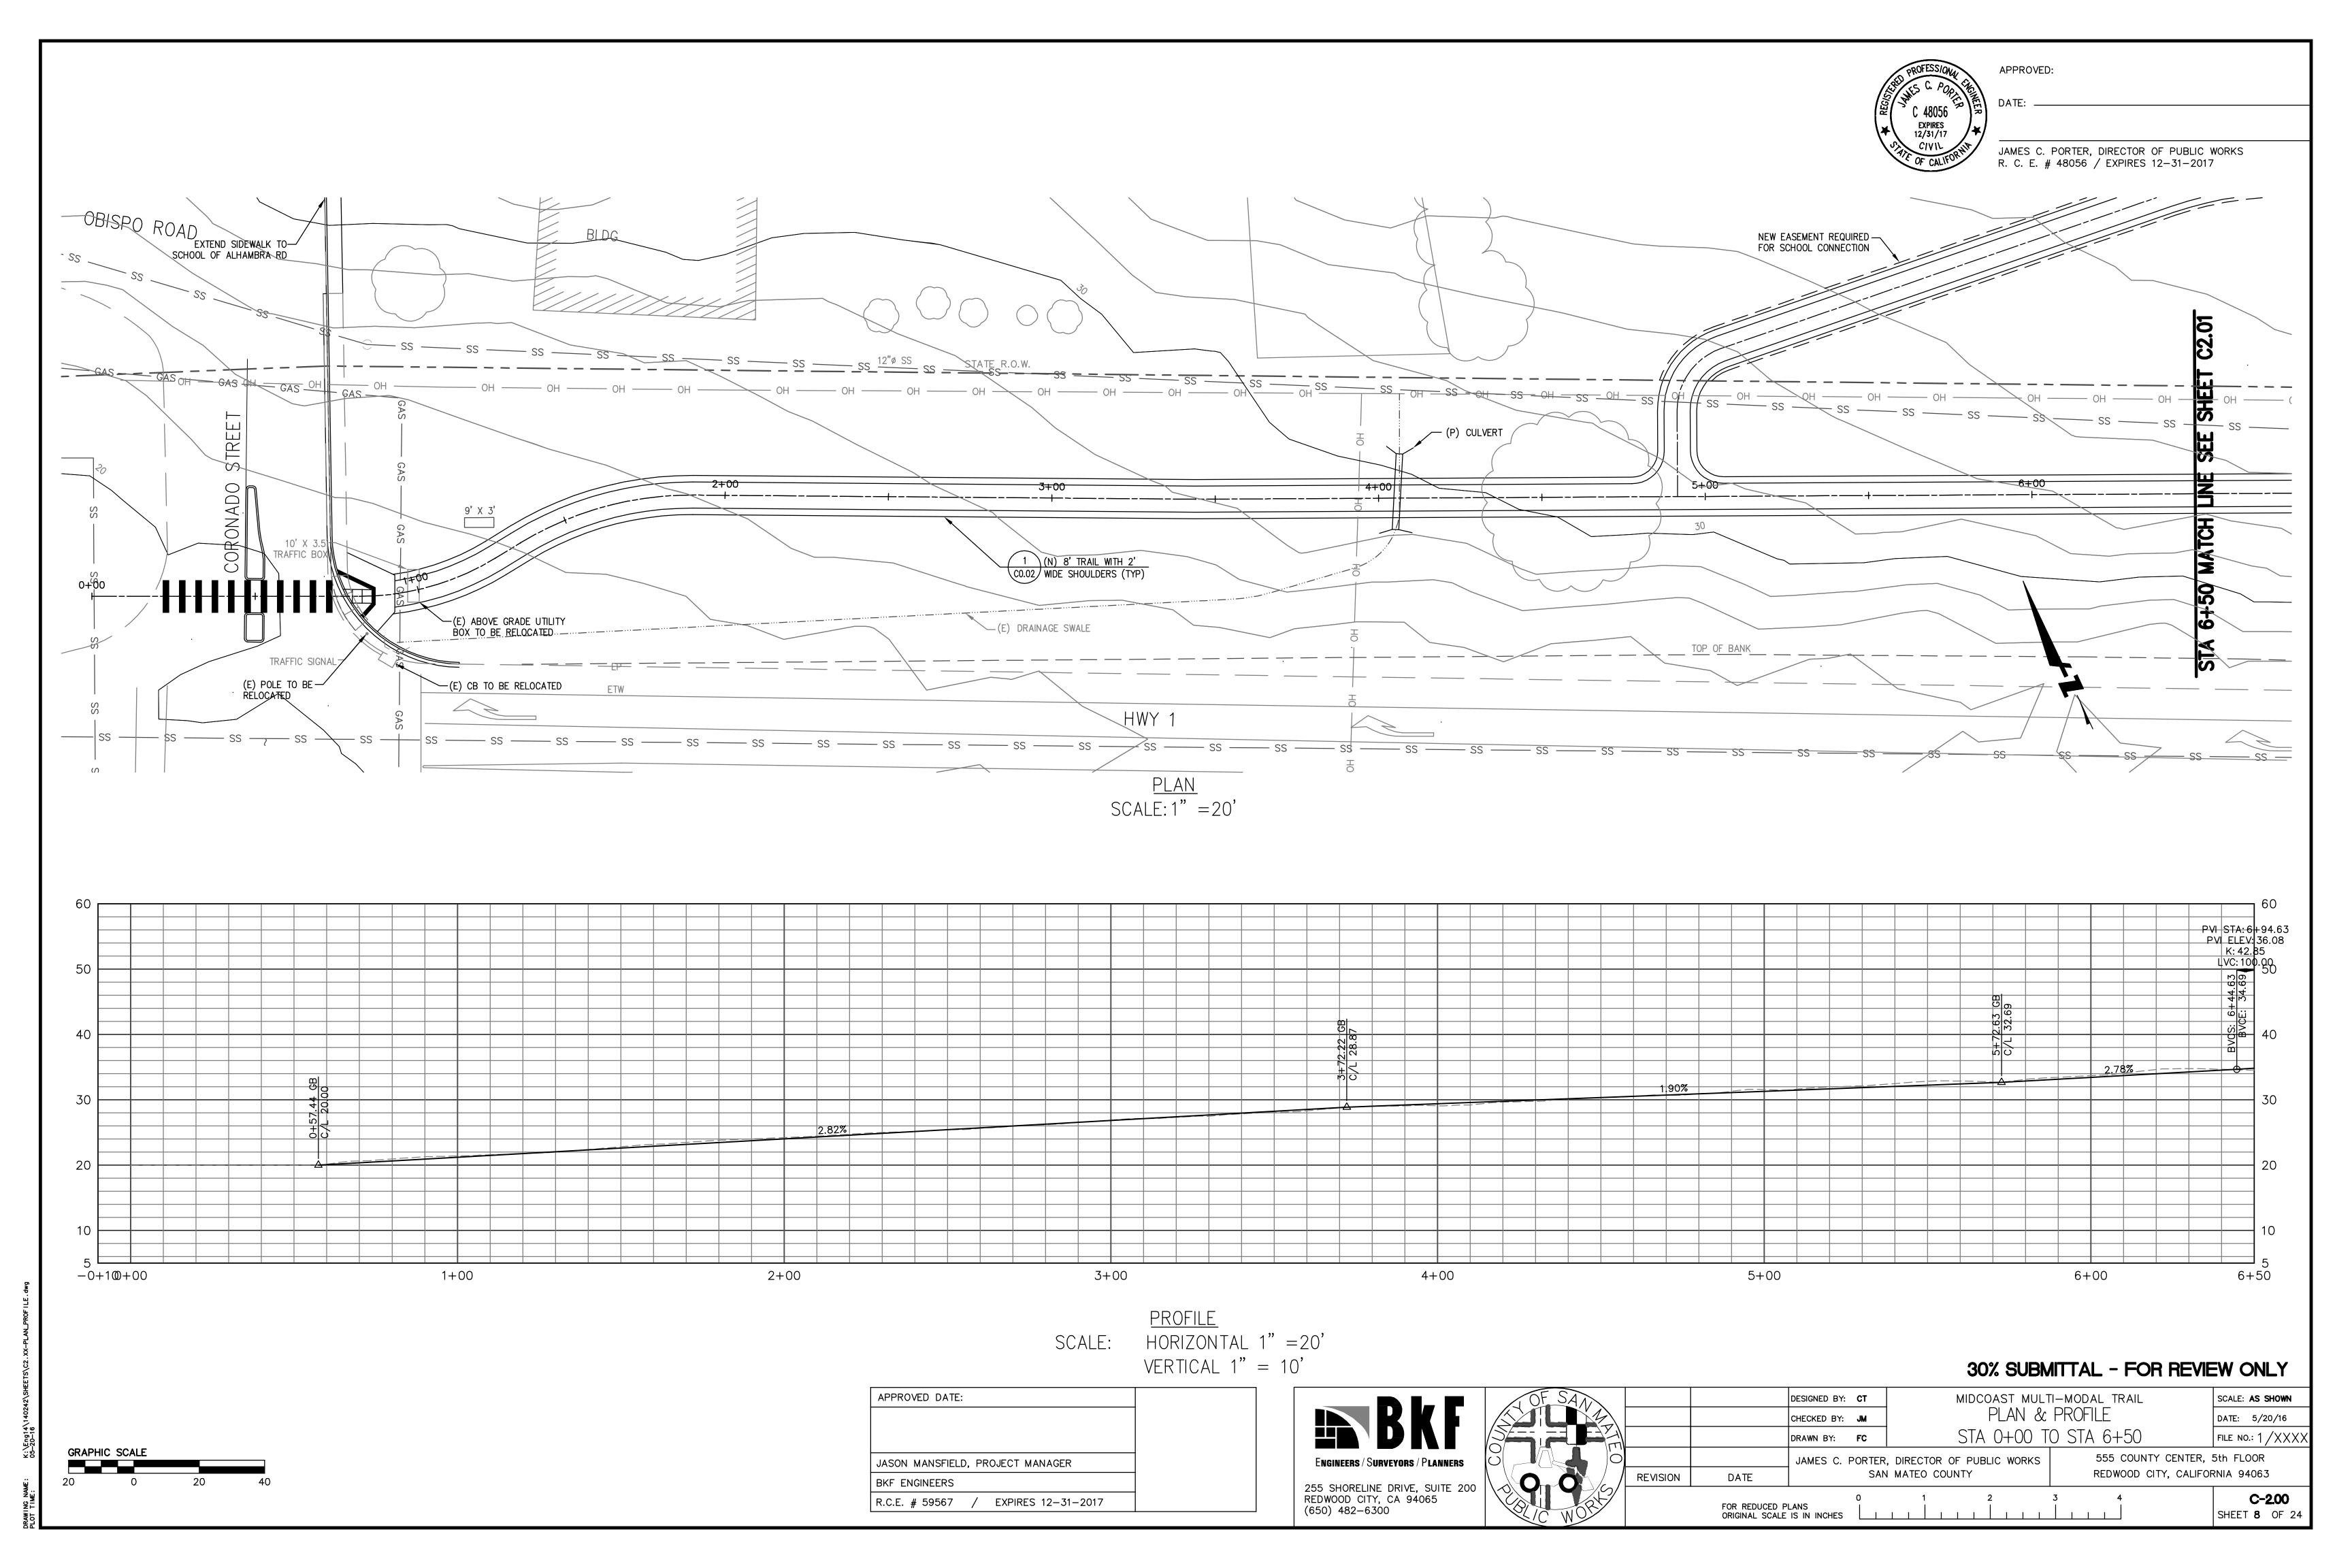


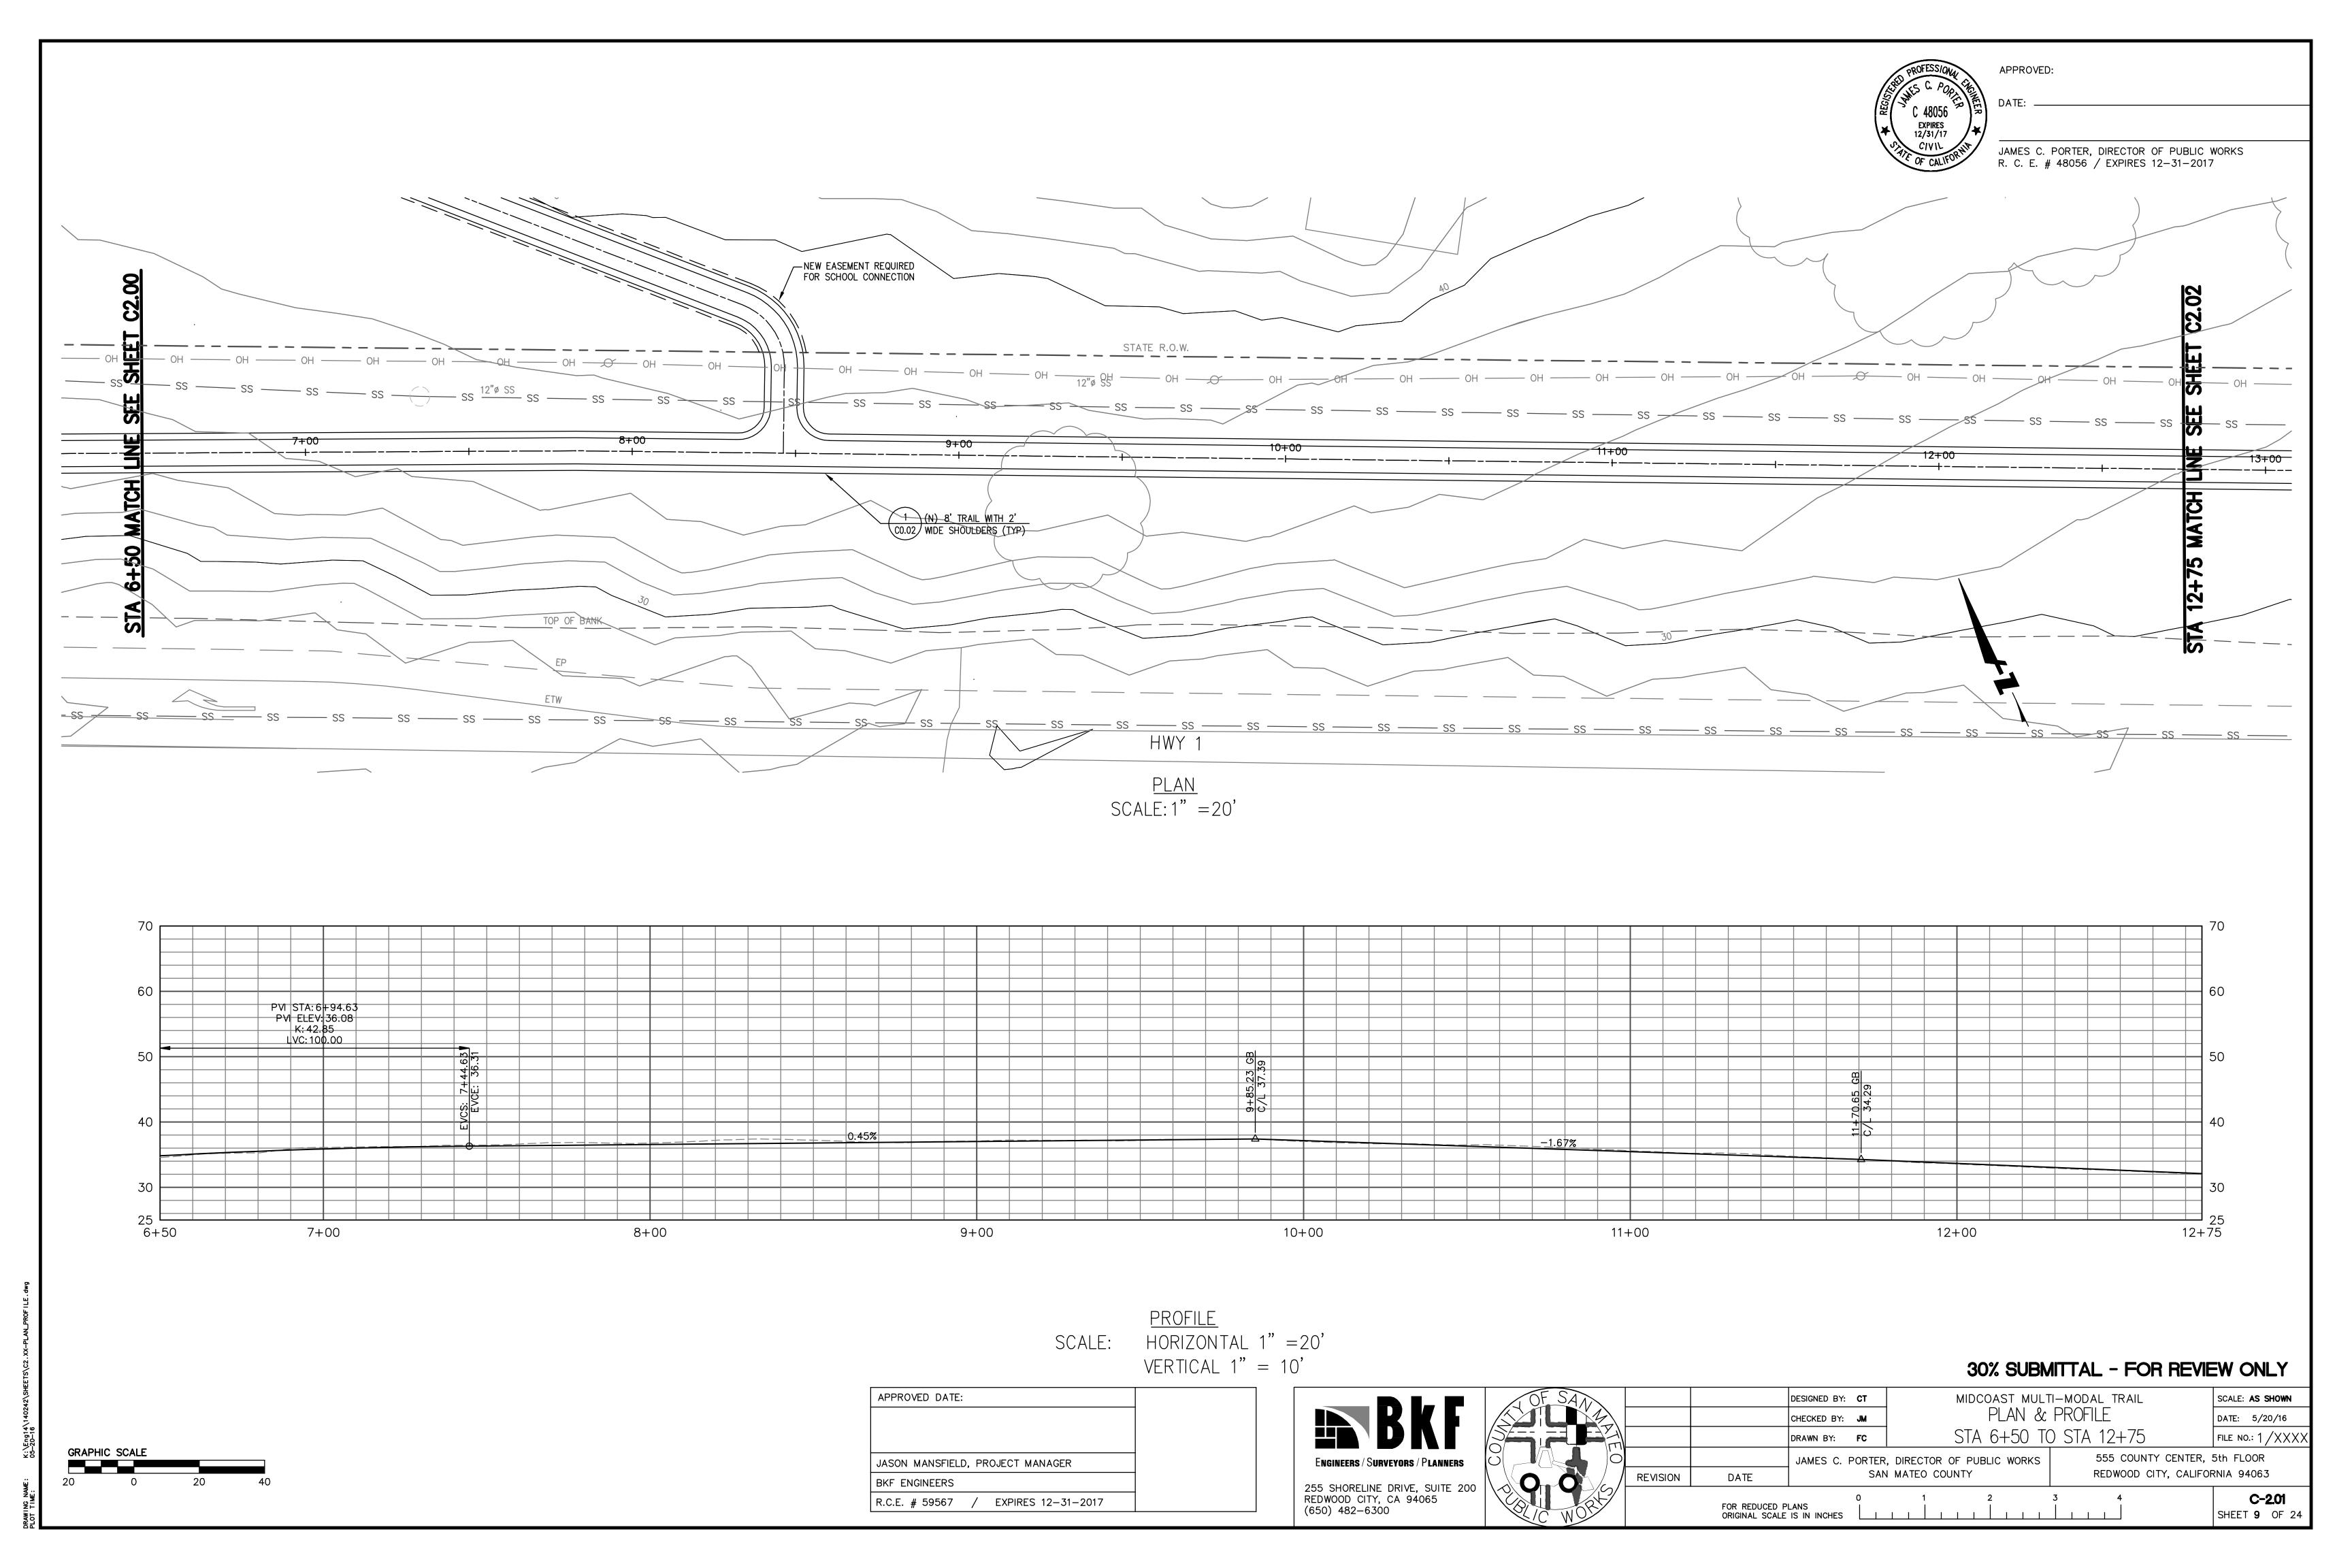

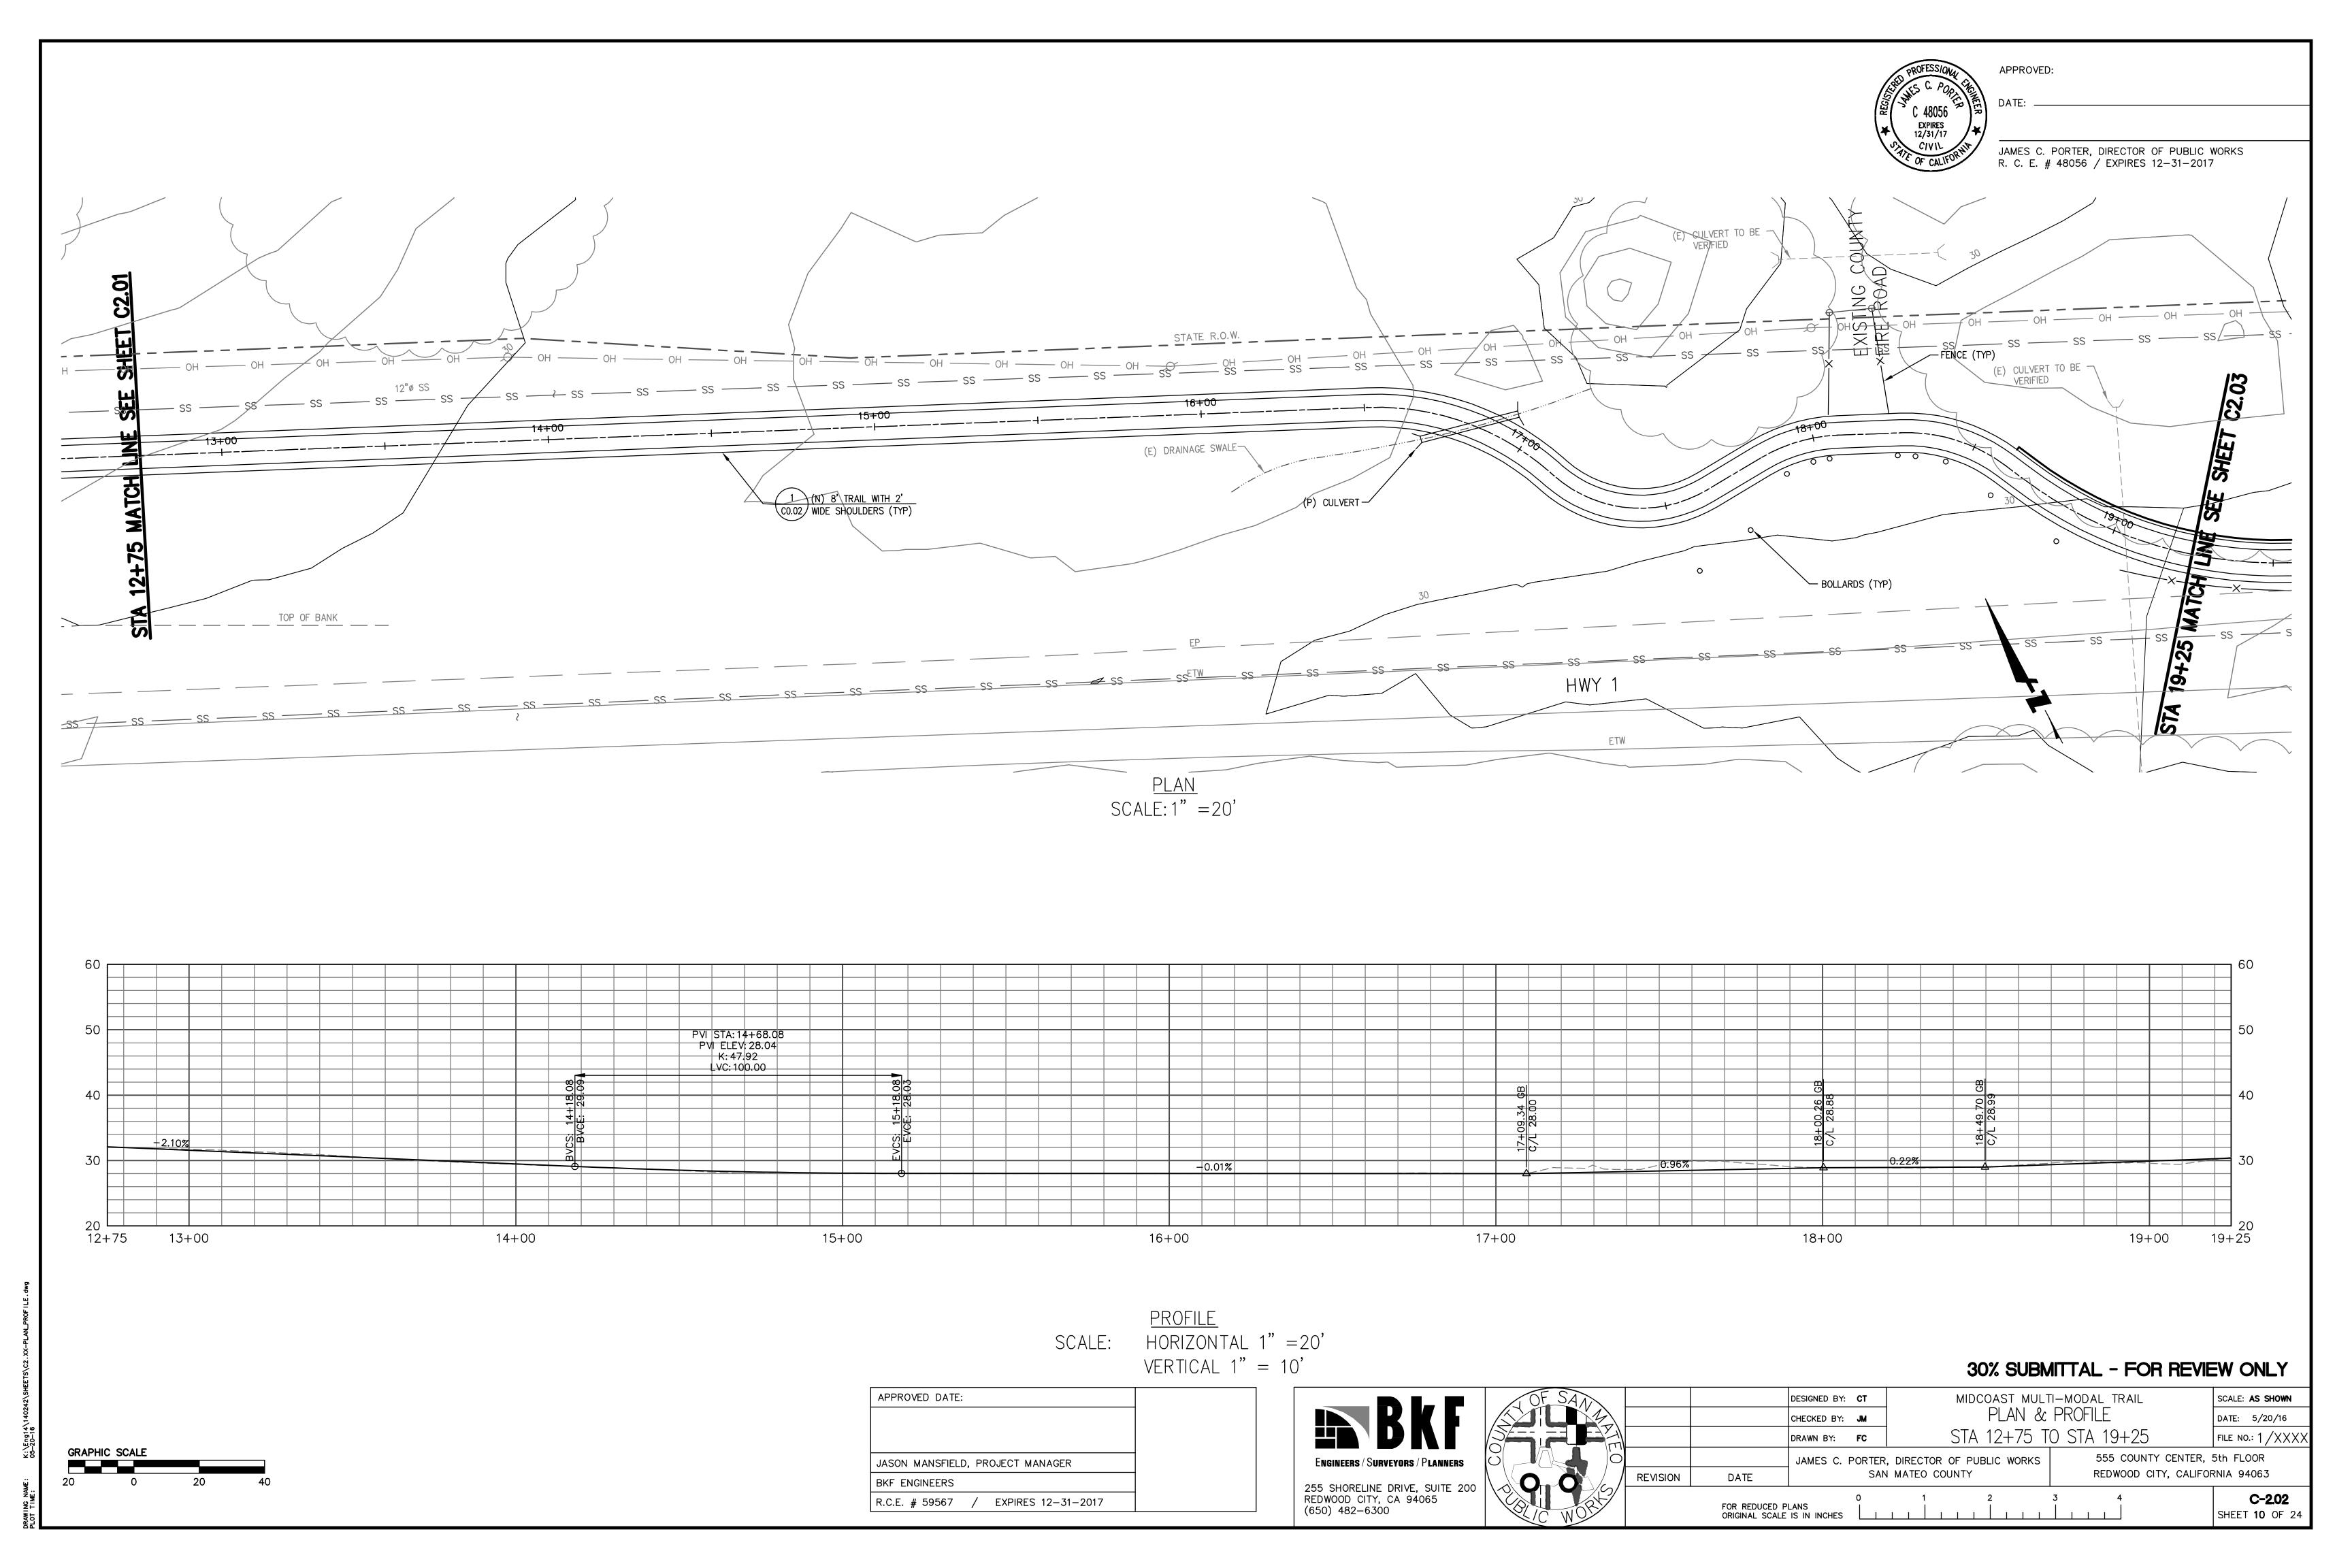

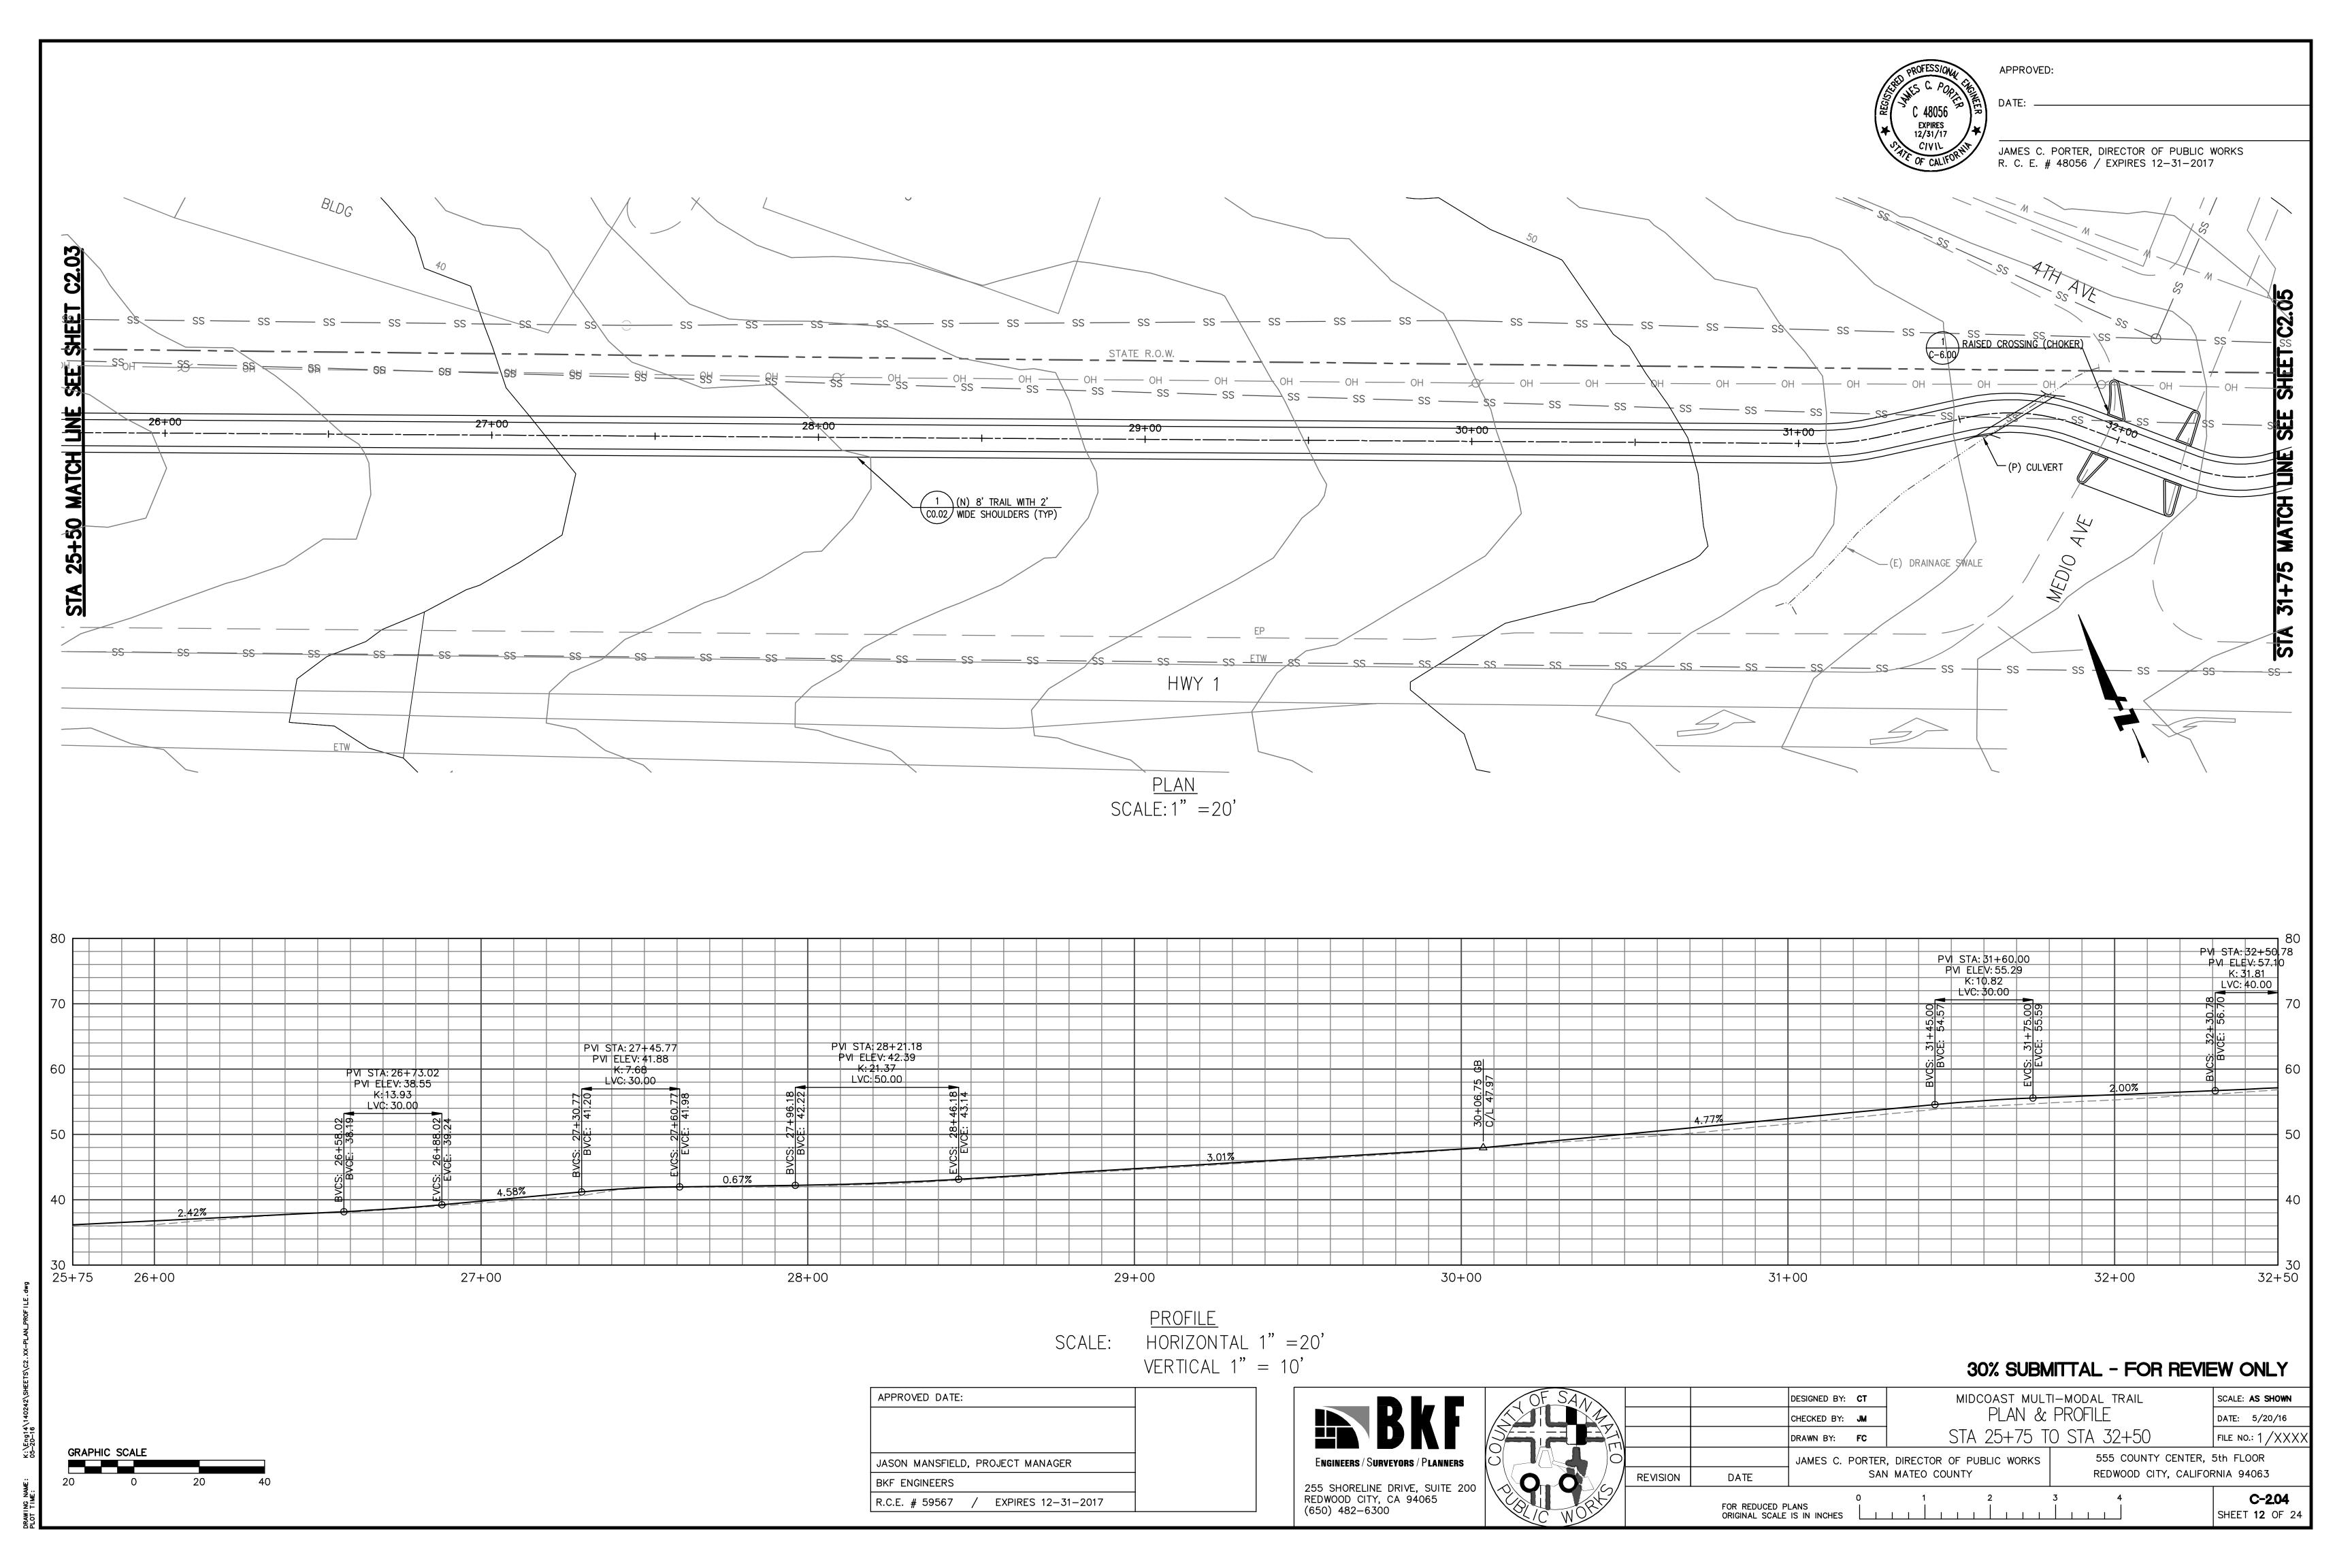

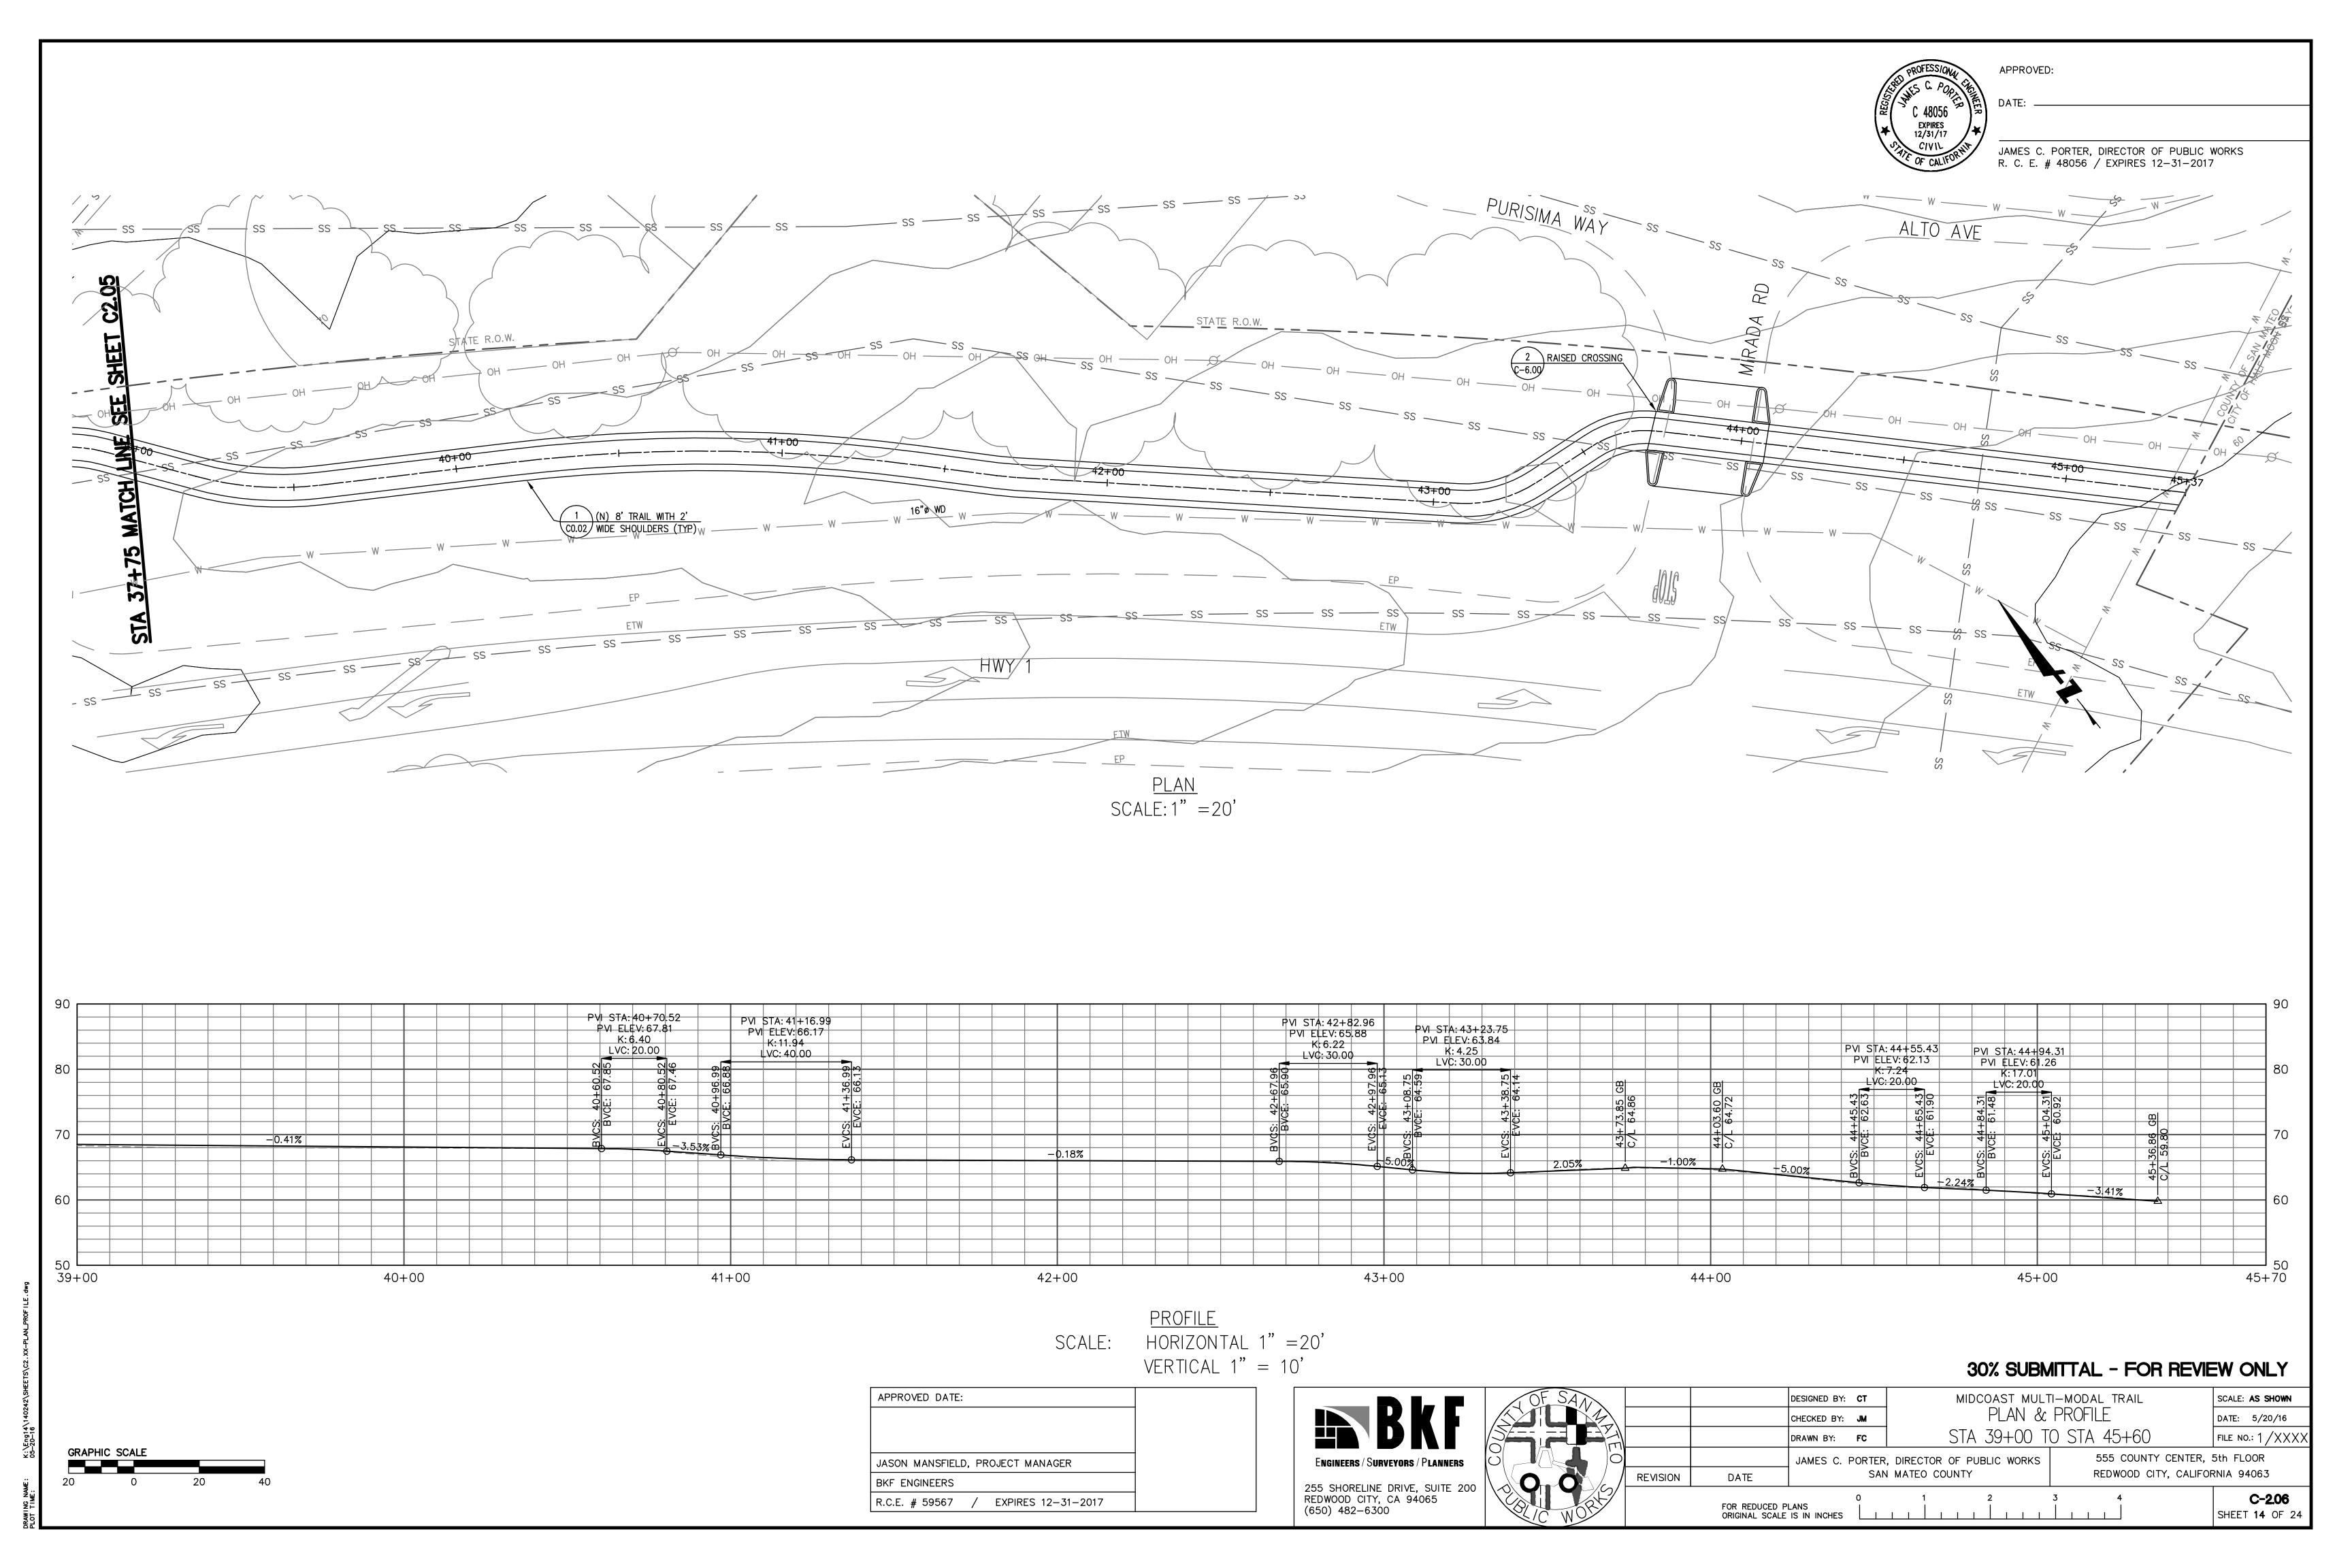

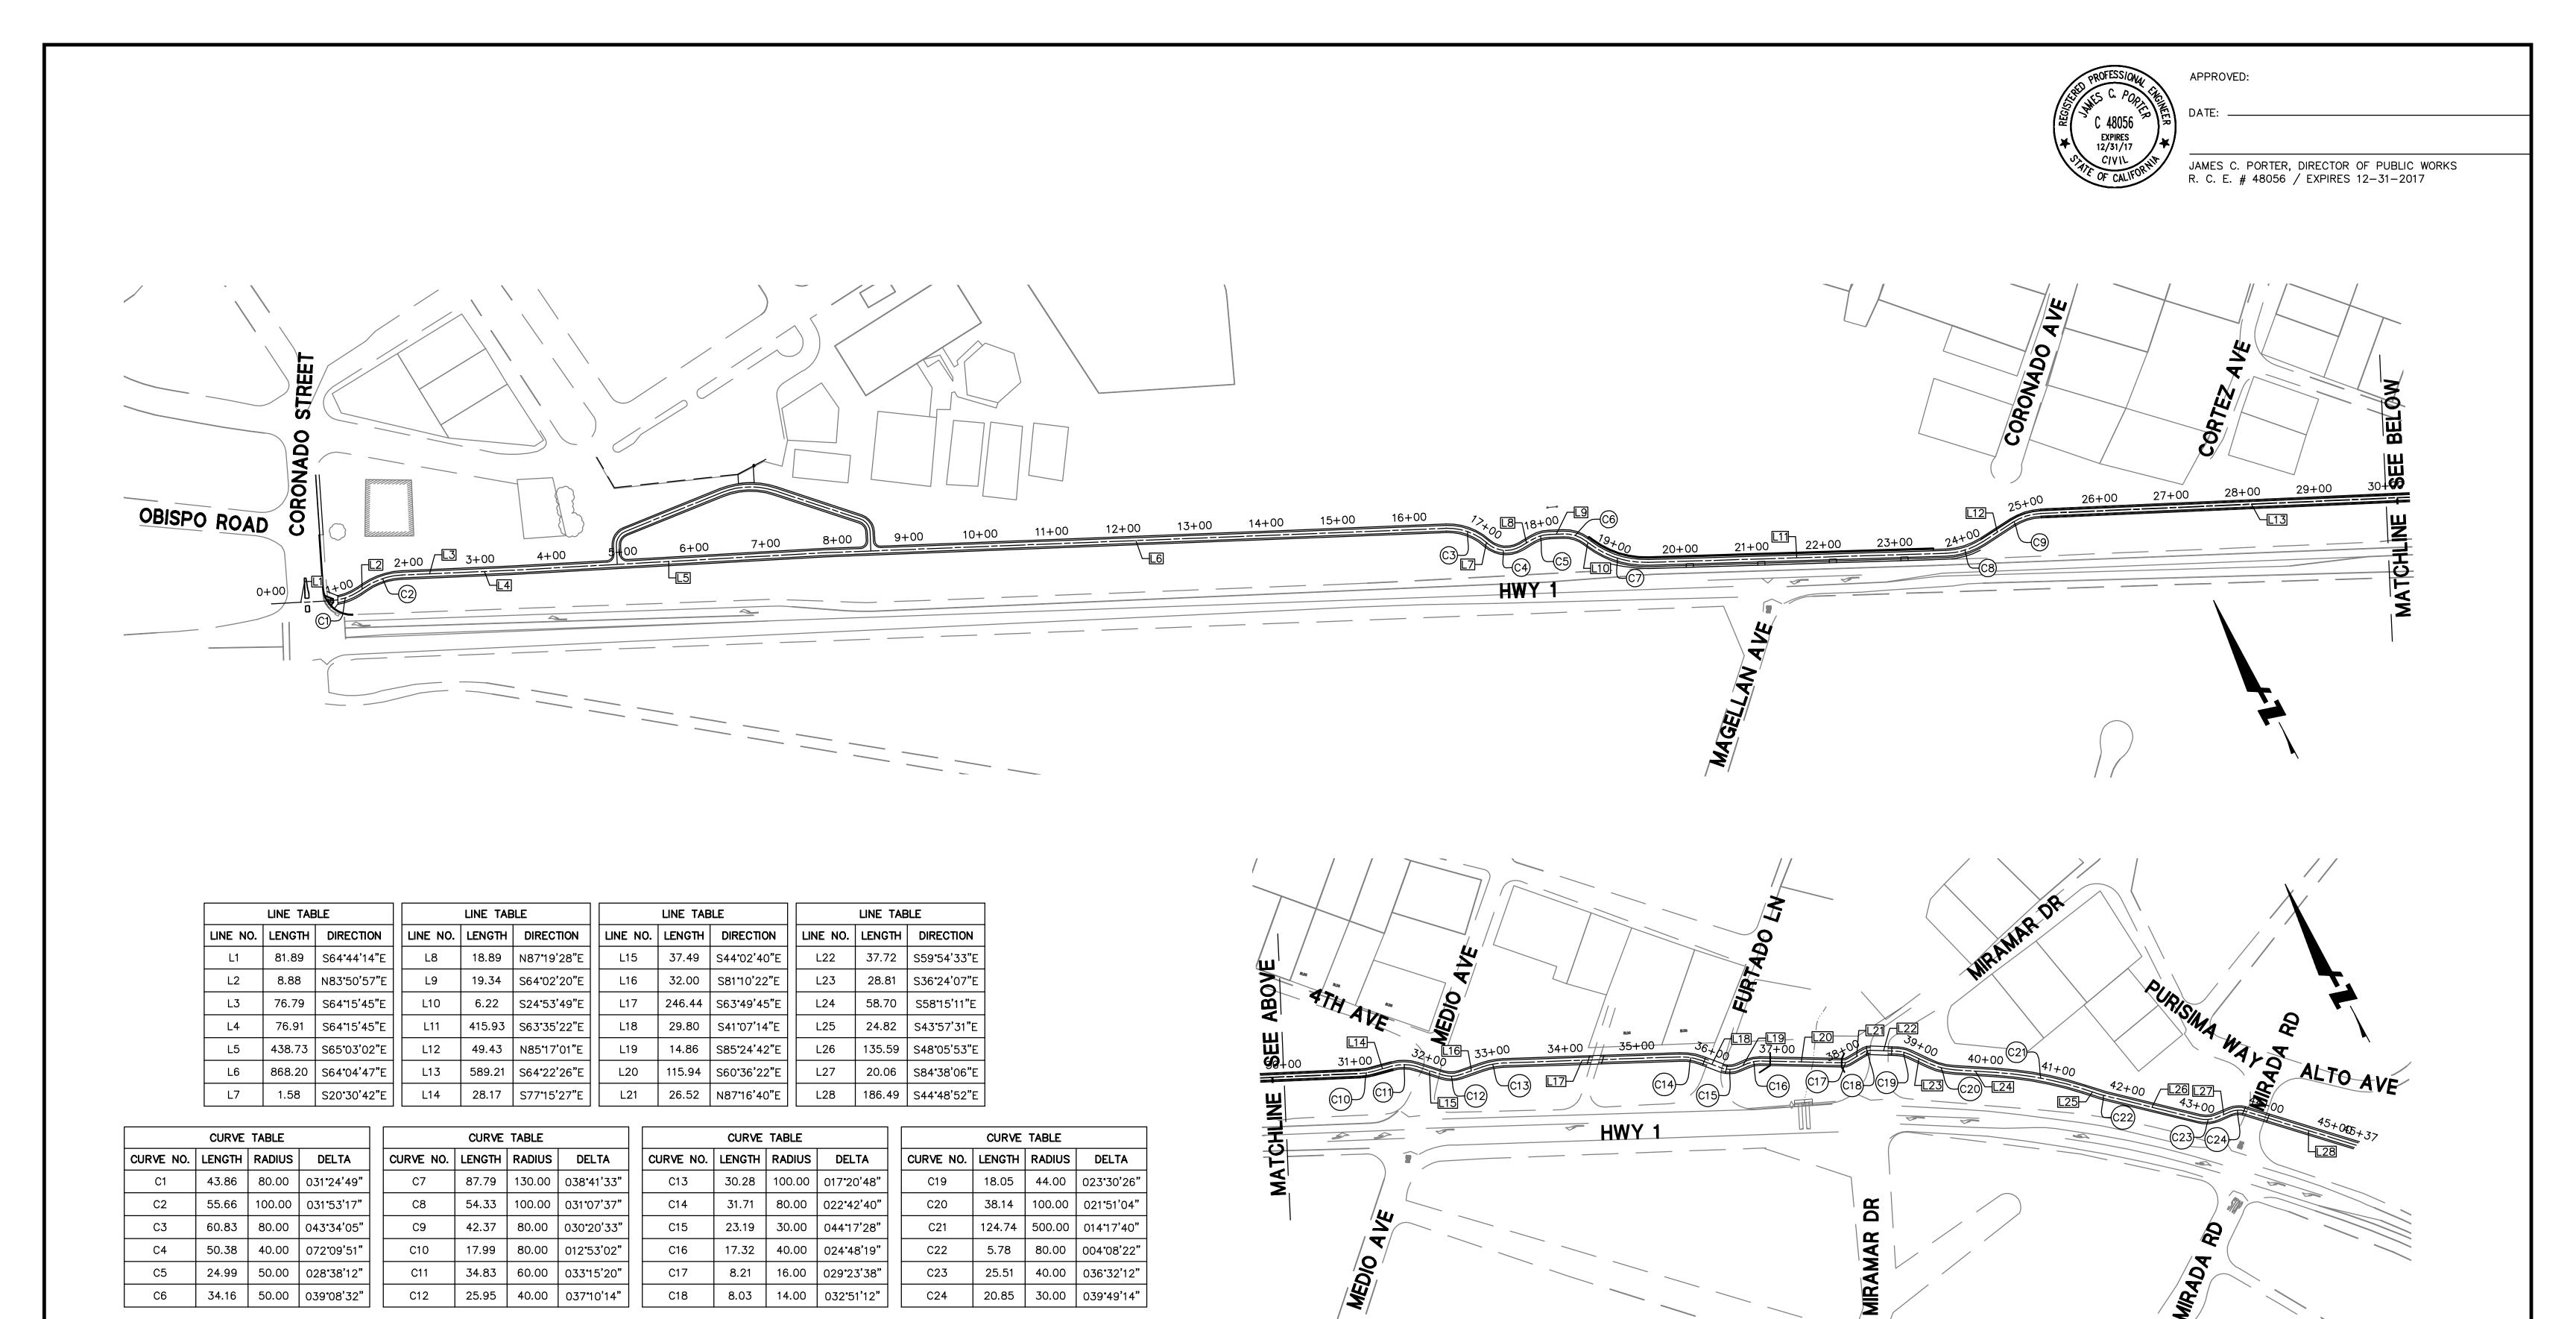

GRAPHIC SCALE				
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APPROVED DATE: JASON MANSFIELD, PROJECT MANAGER BKF ENGINEERS R.C.E. # 59567 / EXPIRES 12-31-2017



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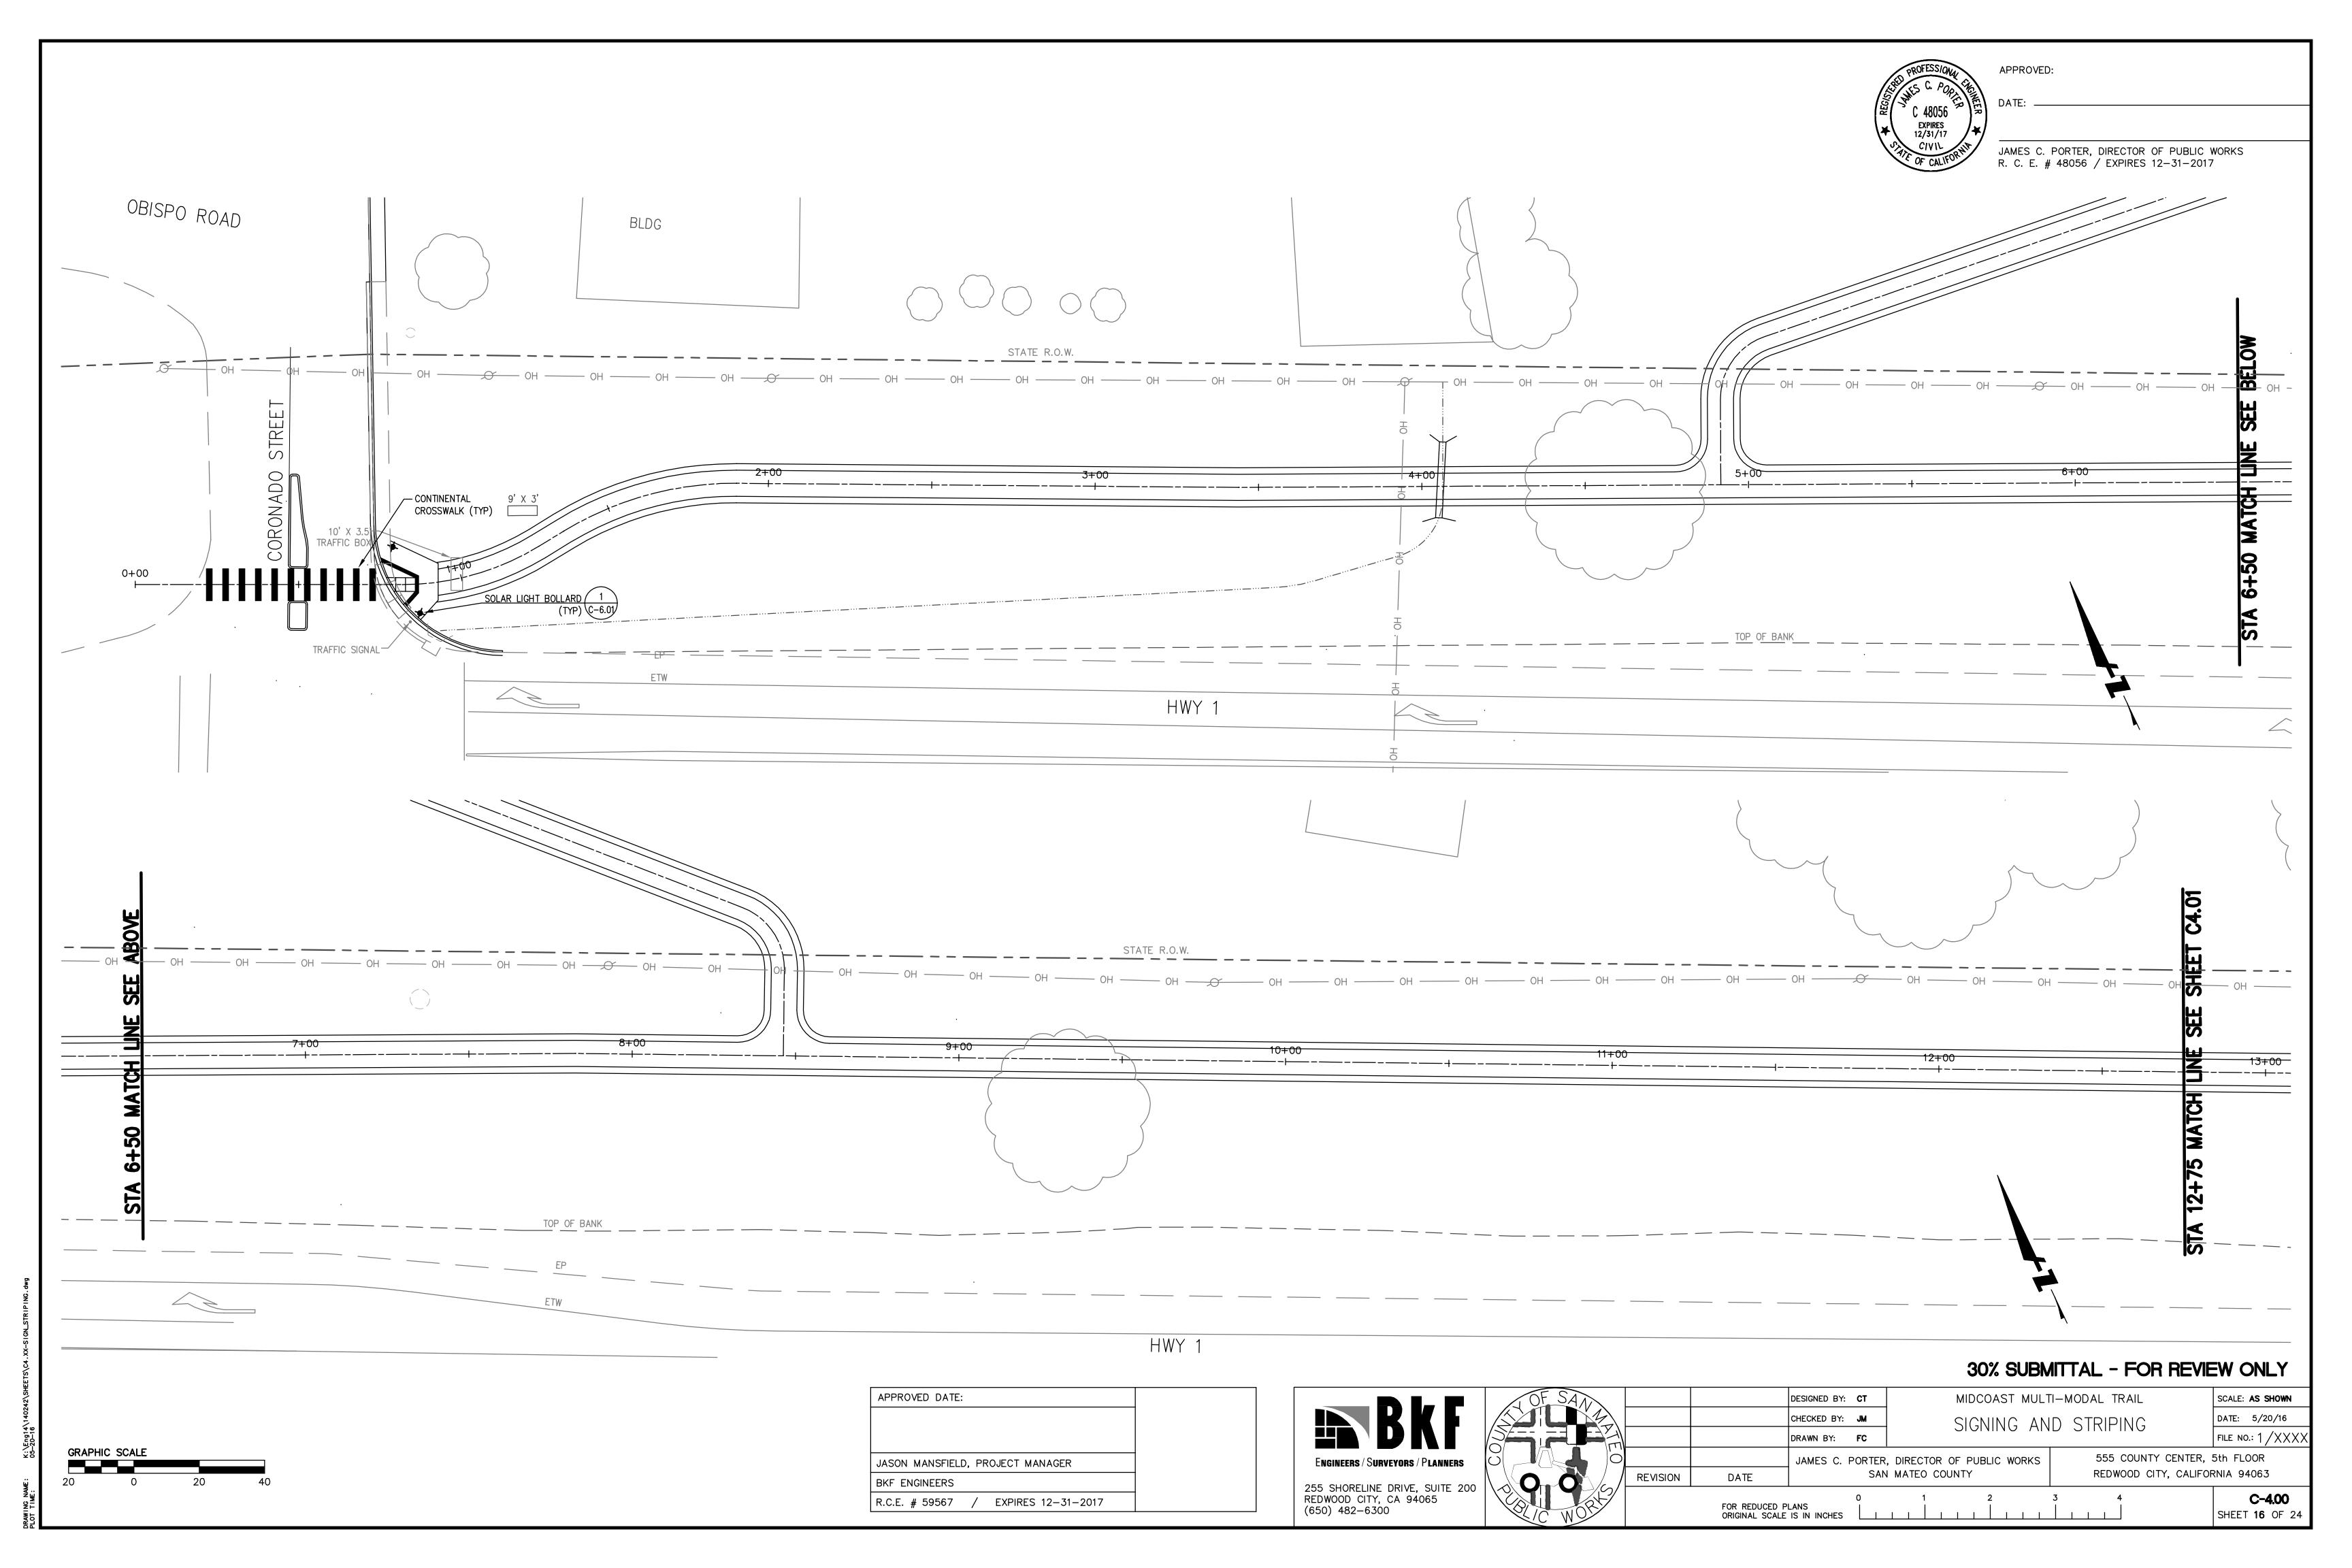
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		JAMES C.	PORTER,	[
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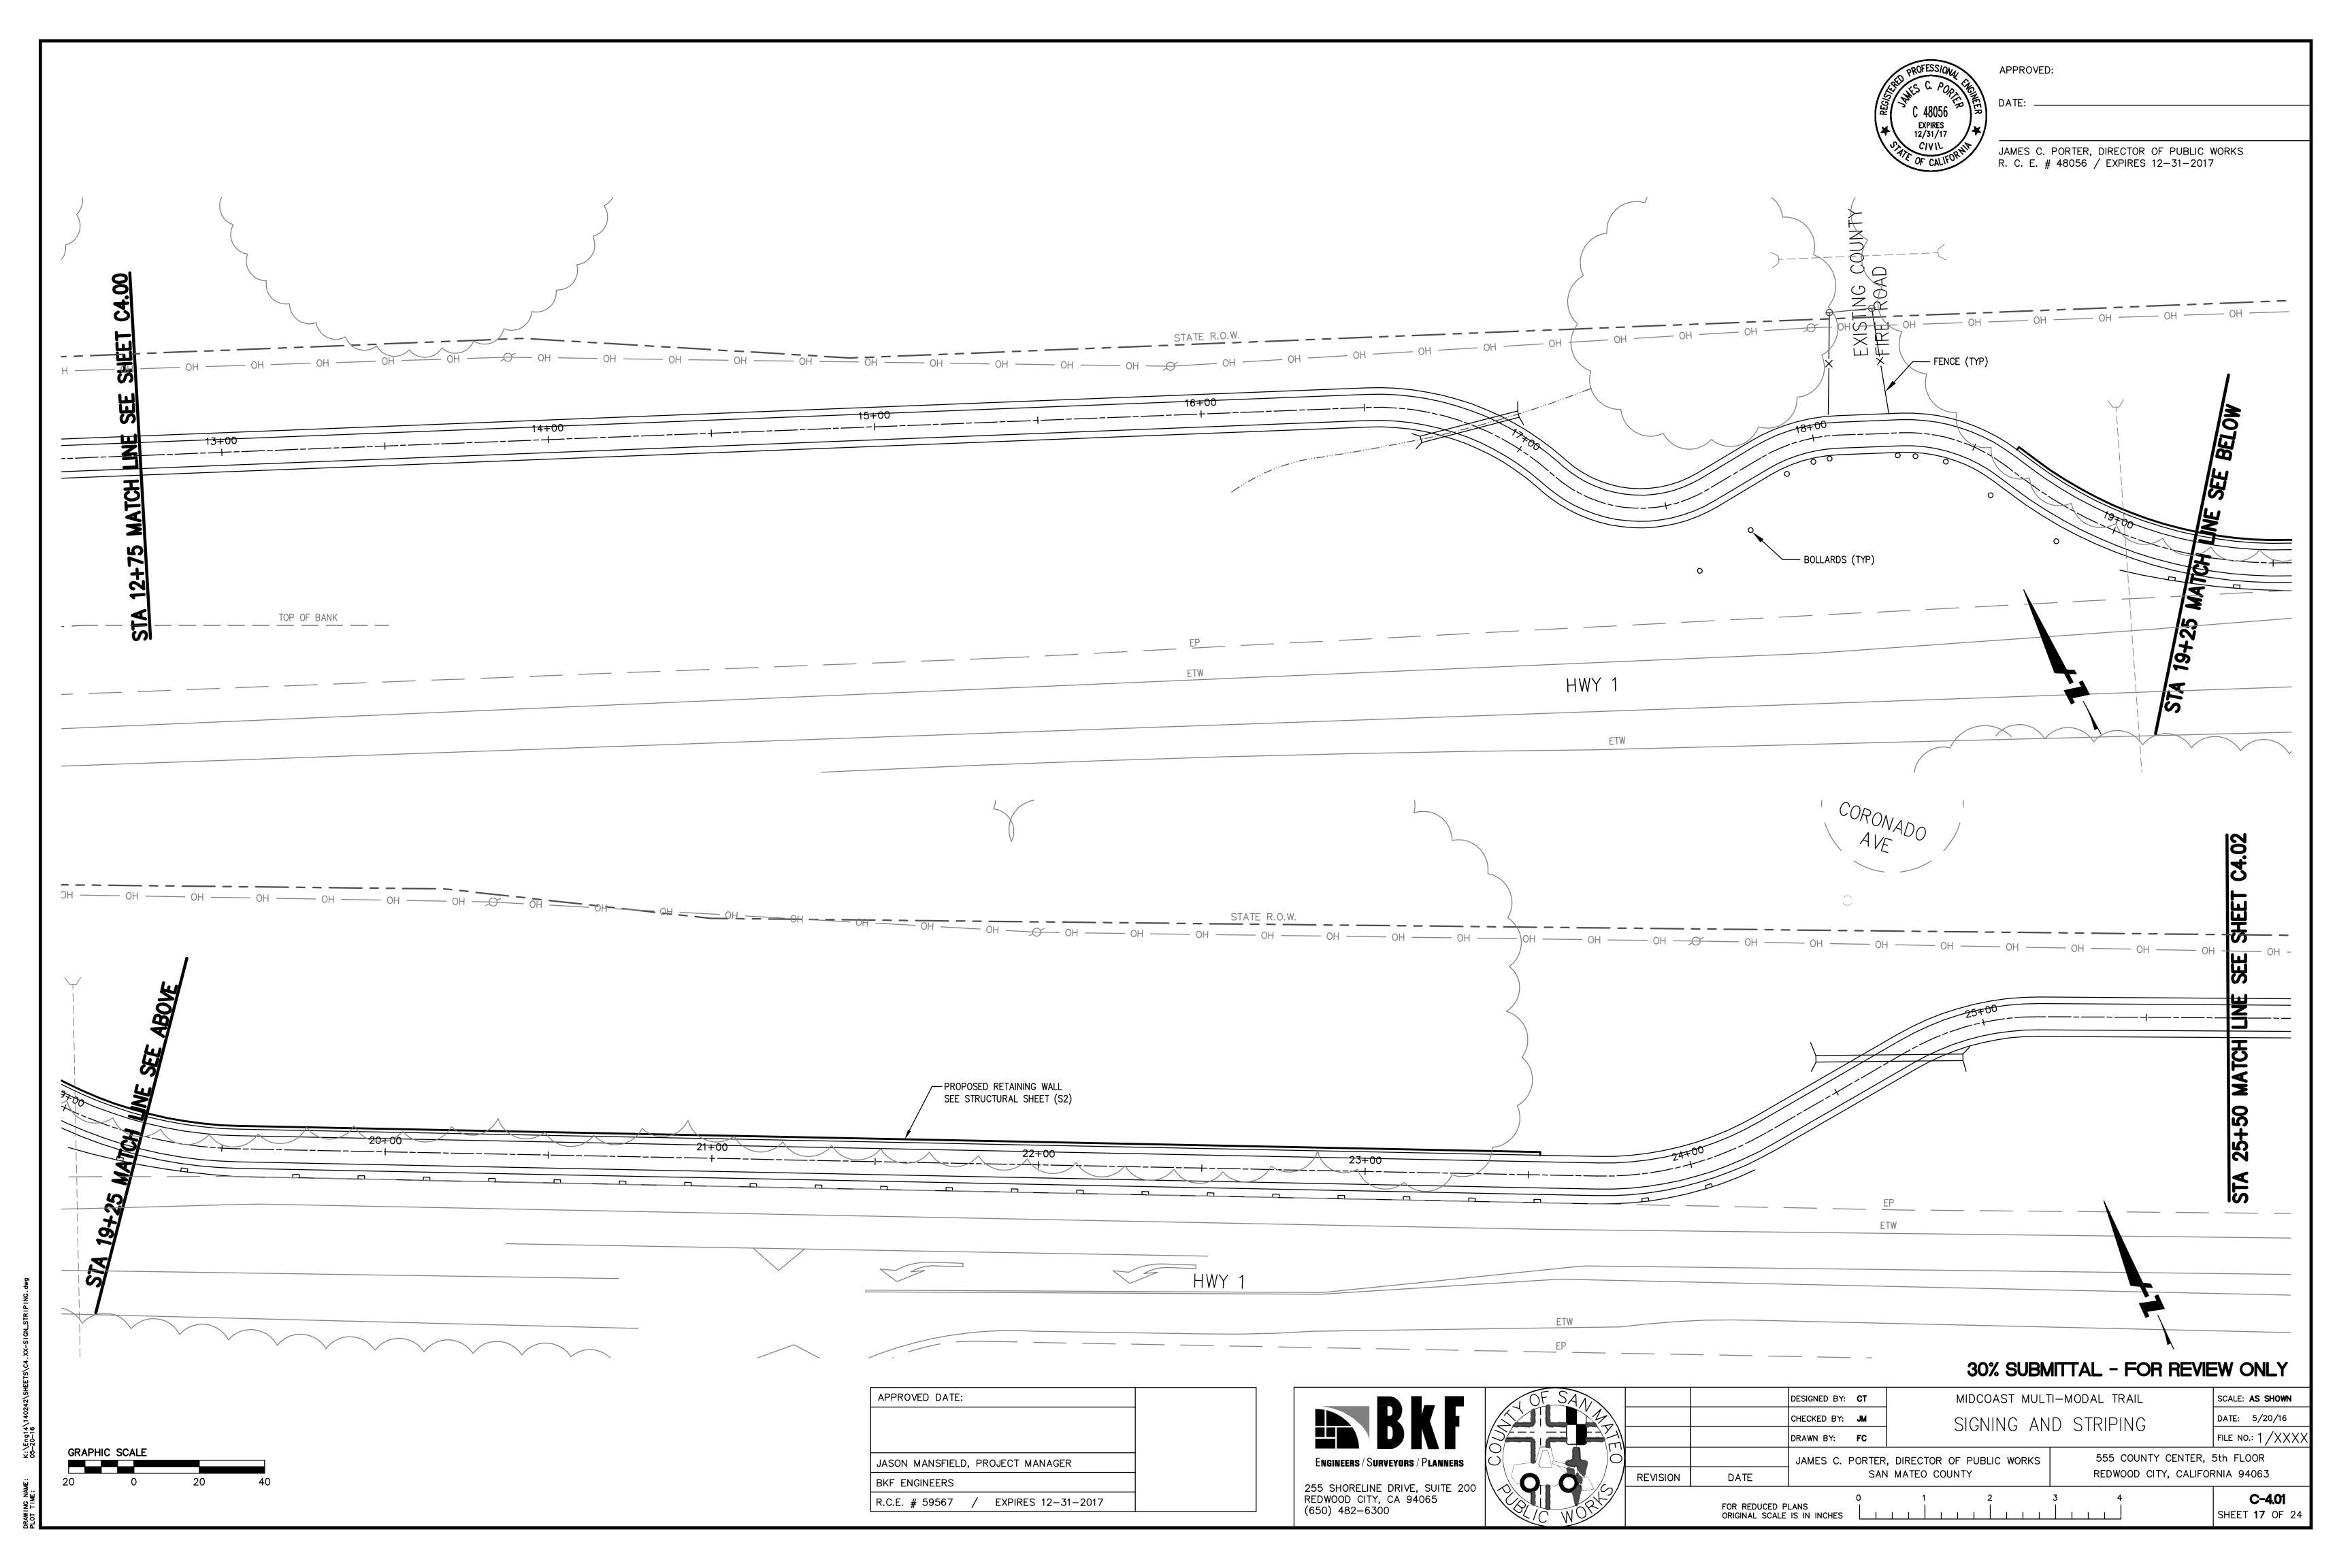
MIDCOAST MULTI-MODAL TRAIL SCALE: 1" = 100'


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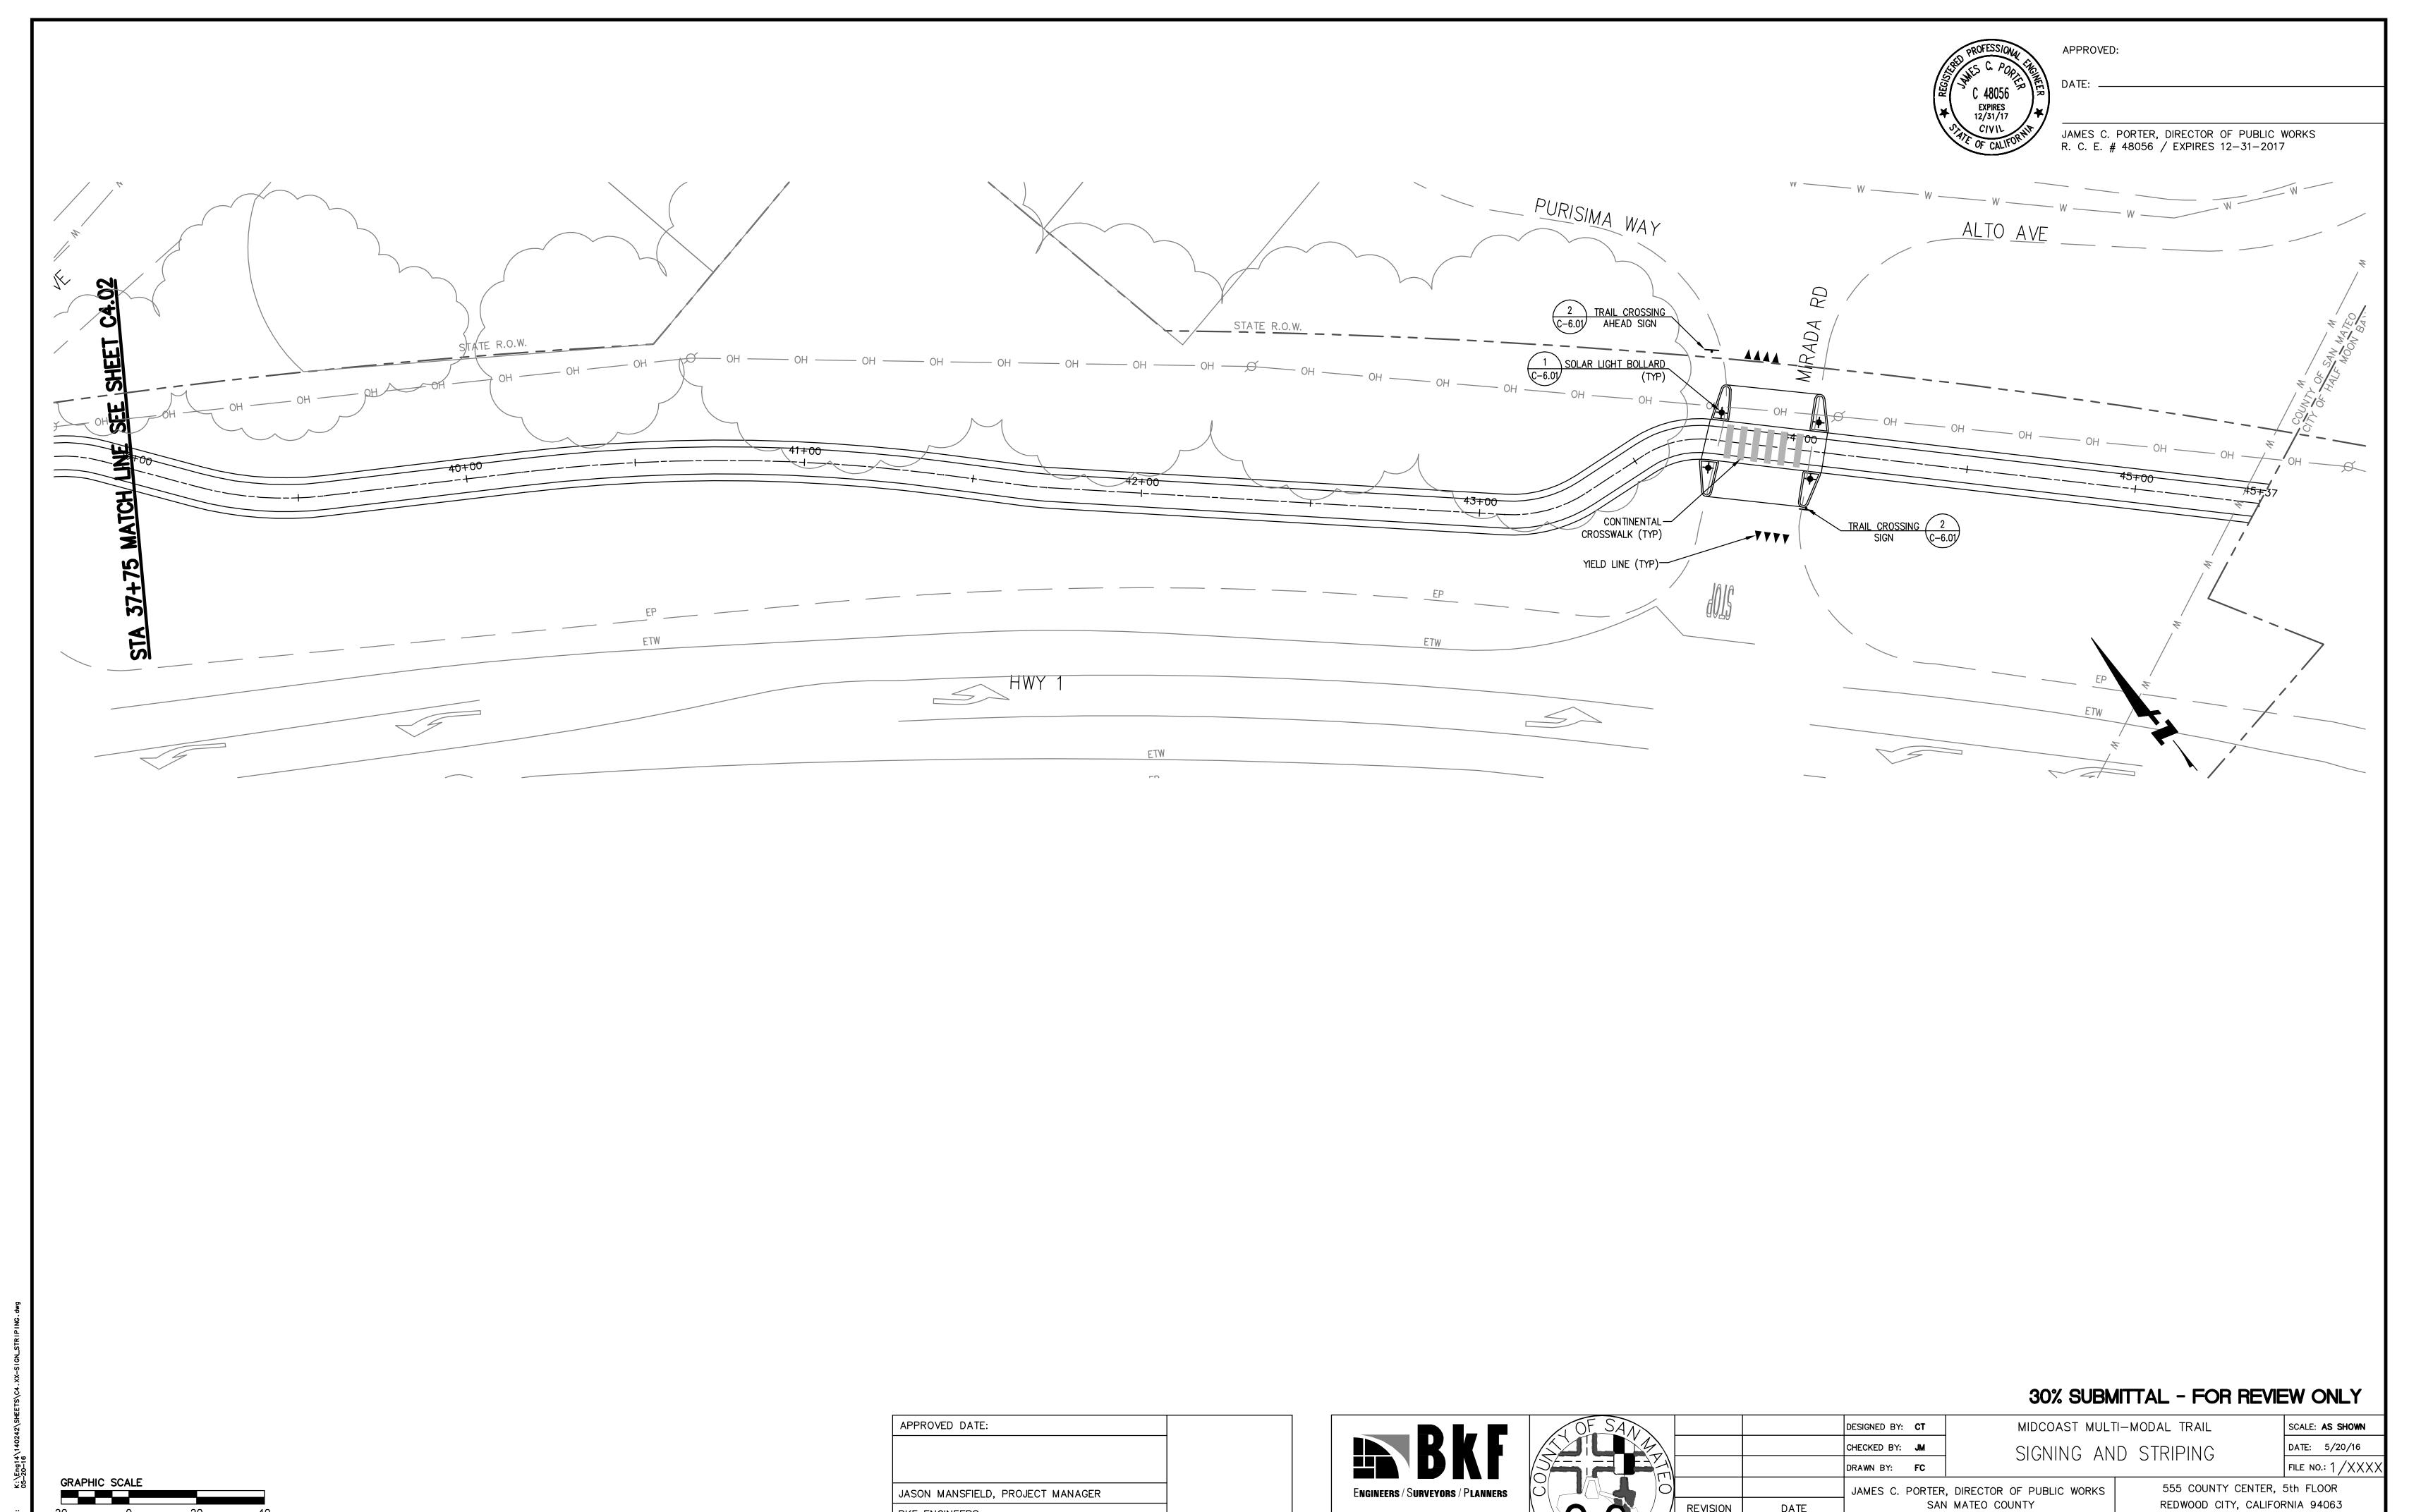
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HORIZONTAL CONTROL PLAN 555 COUNTY CENTER, 5th FLOOR DIRECTOR OF PUBLIC WORKS REDWOOD CITY, CALIFORNIA 94063 SAN MATEO COUNTY REVISION DATE C-3.00 FOR REDUCED PLANS ORIGINAL SCALE IS IN INCHES SHEET **15** OF 24







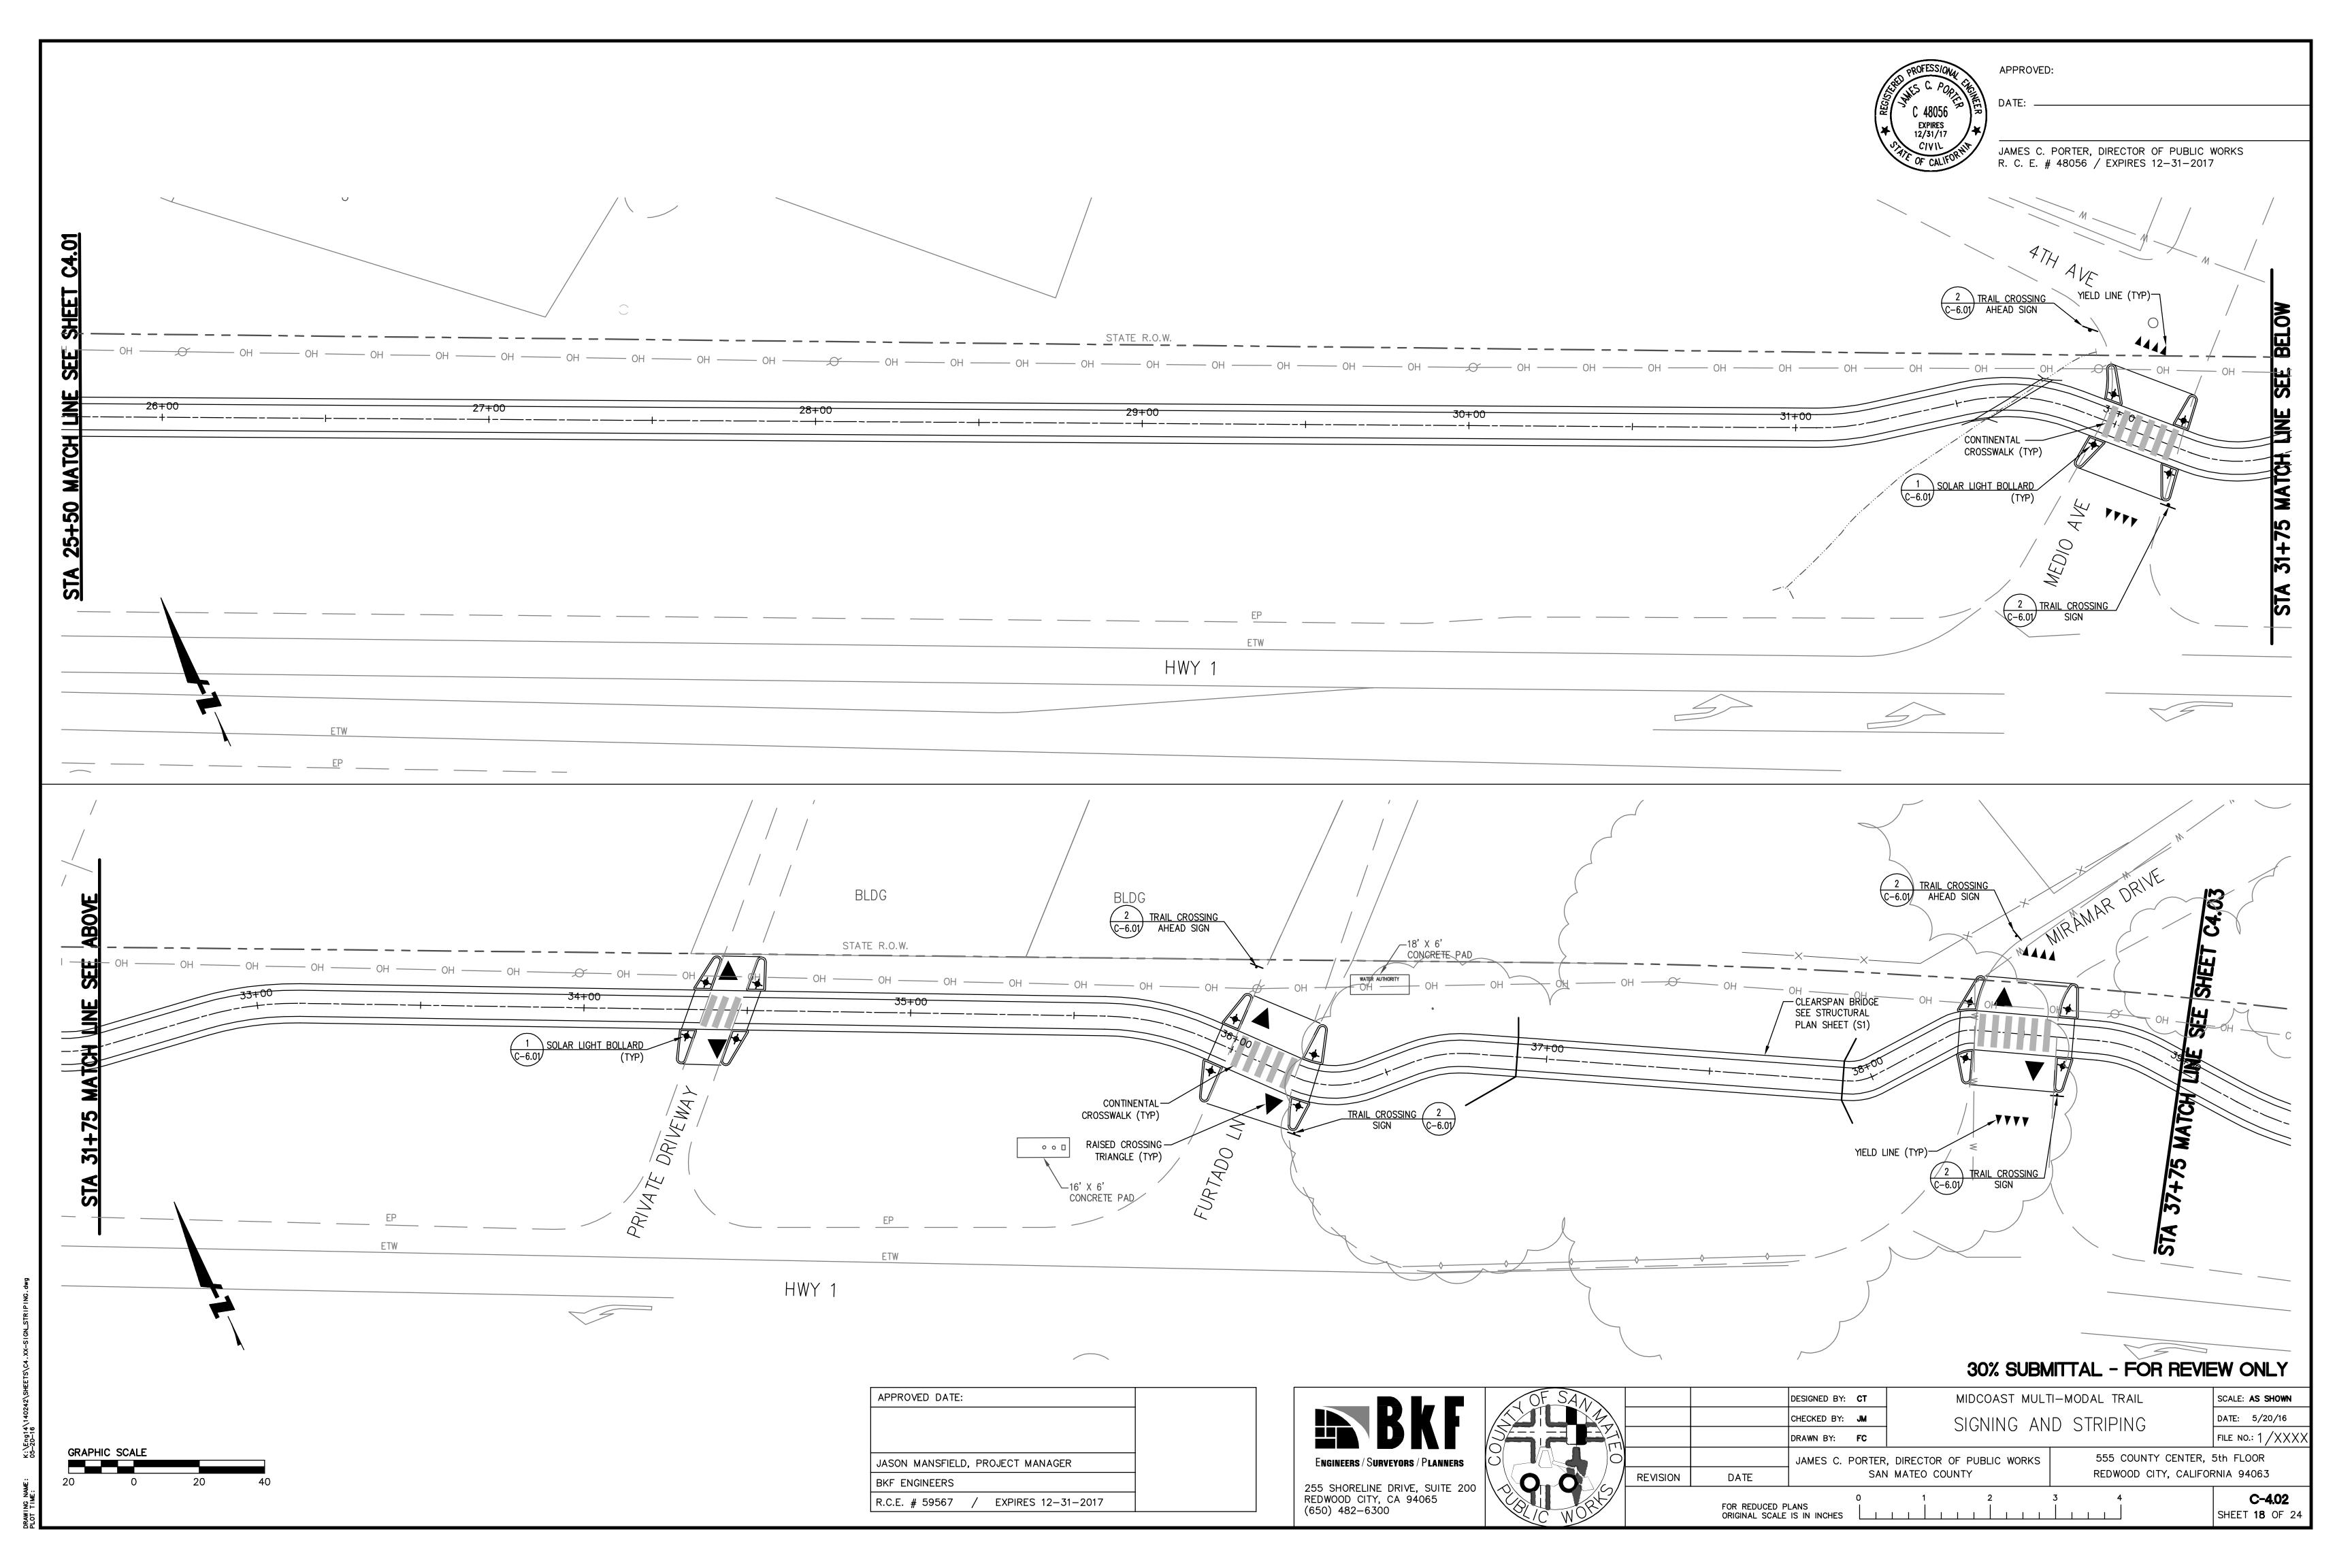

BKF ENGINEERS R.C.E. # 59567 / EXPIRES 12-31-2017

ENGINEERS / SURVEYORS / PLANNERS	
255 SHORELINE DRIVE, SUITE 200 REDWOOD CITY, CA 94065 (650) 482-6300	

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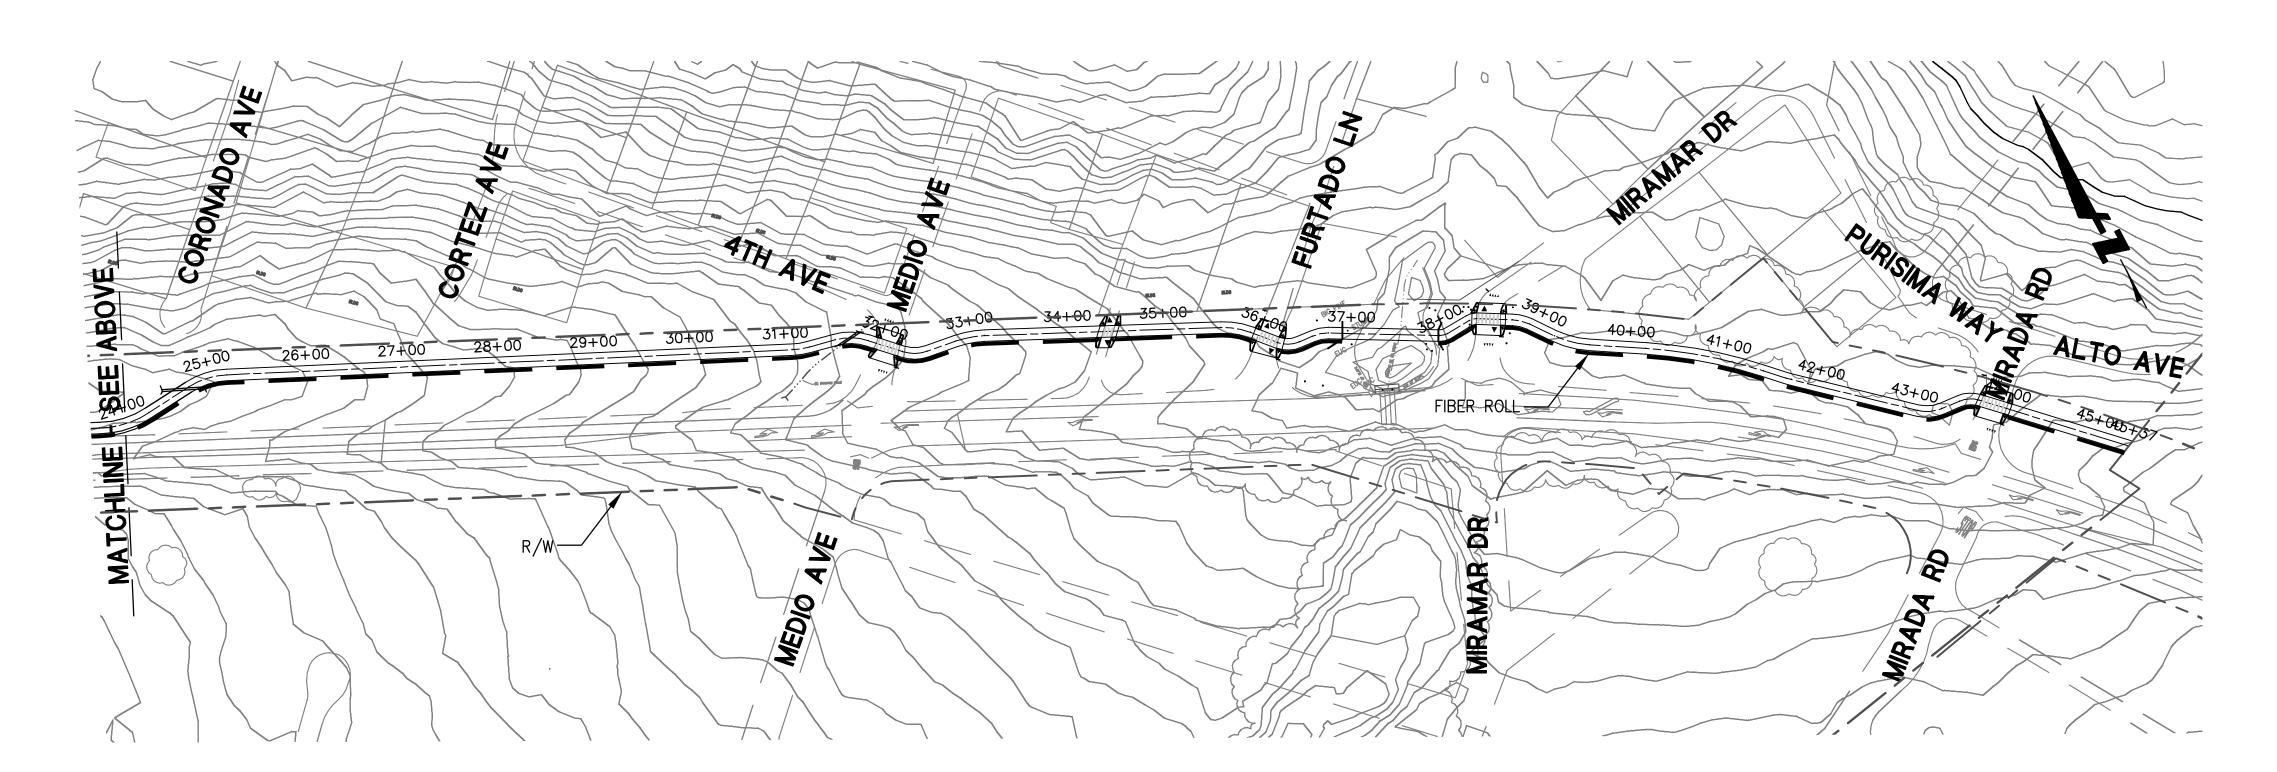
SHEET **19** OF 24



APPROVED:

JAMES C. PORTER, DIRECTOR OF PUBLIC WORKS R. C. E. # 48056 / EXPIRES 12-31-2017





30% SUBMITTAL - FOR REVIEW ONLY

SCALE: 1" = 100'

DATE: 5/20/16

FILE NO.: 1/XXXX


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SHEET 20 OF 24

APPROVED DATE:	
JASON MANSFIELD, PROJECT MANAGER	-
BKF ENGINEERS	7
R.C.E. # 59567 / EXPIRES 12-31-2017	7


GRAPHIC SCALE

	OF SAA			DESIGNED BY: CT	MIDCOAST MULT	T-MODAL TRAIL	SCALE: 1" = 1
				CHECKED BY: JM	FRASIAN CA	NTROL PLAN	DATE: 5/20/
				DRAWN BY: FC		INTINOL I LAIN	FILE NO.: 1/
Engineers / Surveyors / Planners				JAMES C. PORTER	, DIRECTOR OF PUBLIC WORKS	555 COUNTY CENTER,	5th FLOOR
OFF CHORELINE DRIVE CHITE OOO		REVISION	DATE	SAN	I MATEO COUNTY	REDWOOD CITY, CALIFO	RNIA 94063
255 SHORELINE DRIVE, SUITE 200 REDWOOD CITY, CA 94065 (650) 482-6300	OLC WORLS		FOR REDUCED P ORIGINAL SCALE		1 2	3 4	C-5.0 SHEET 20 0

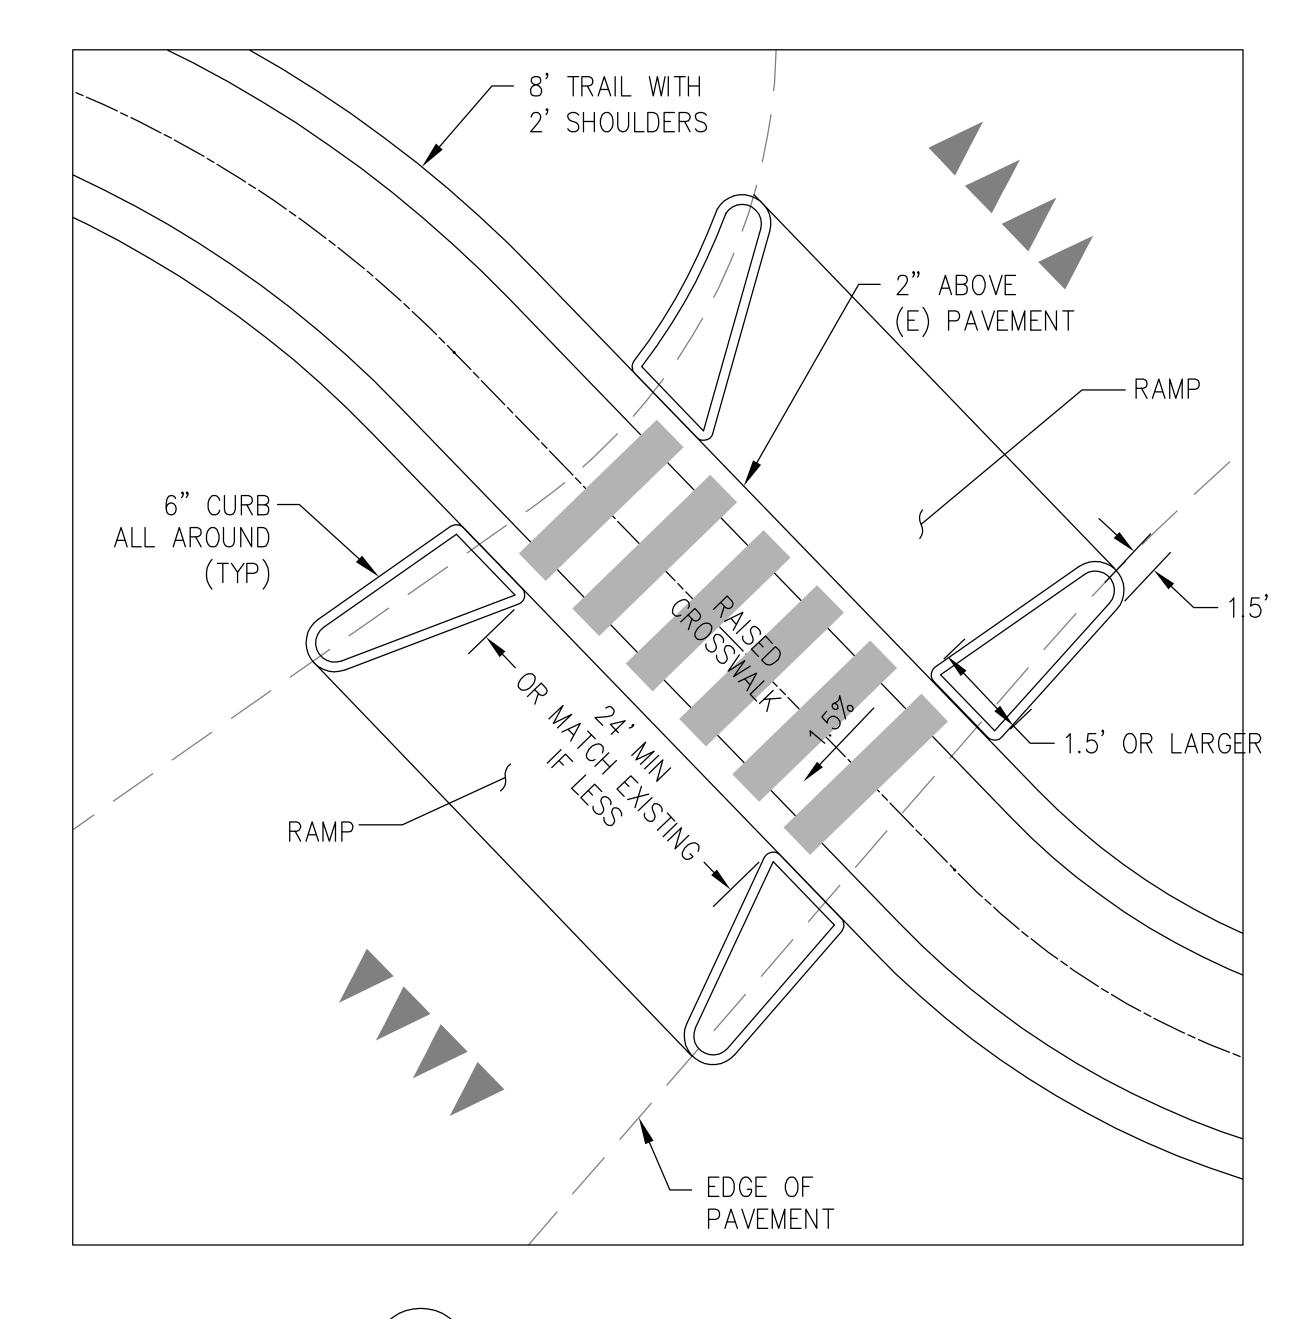

RAISED CROSSING (CHOKER)

SCALE: 1" = 5

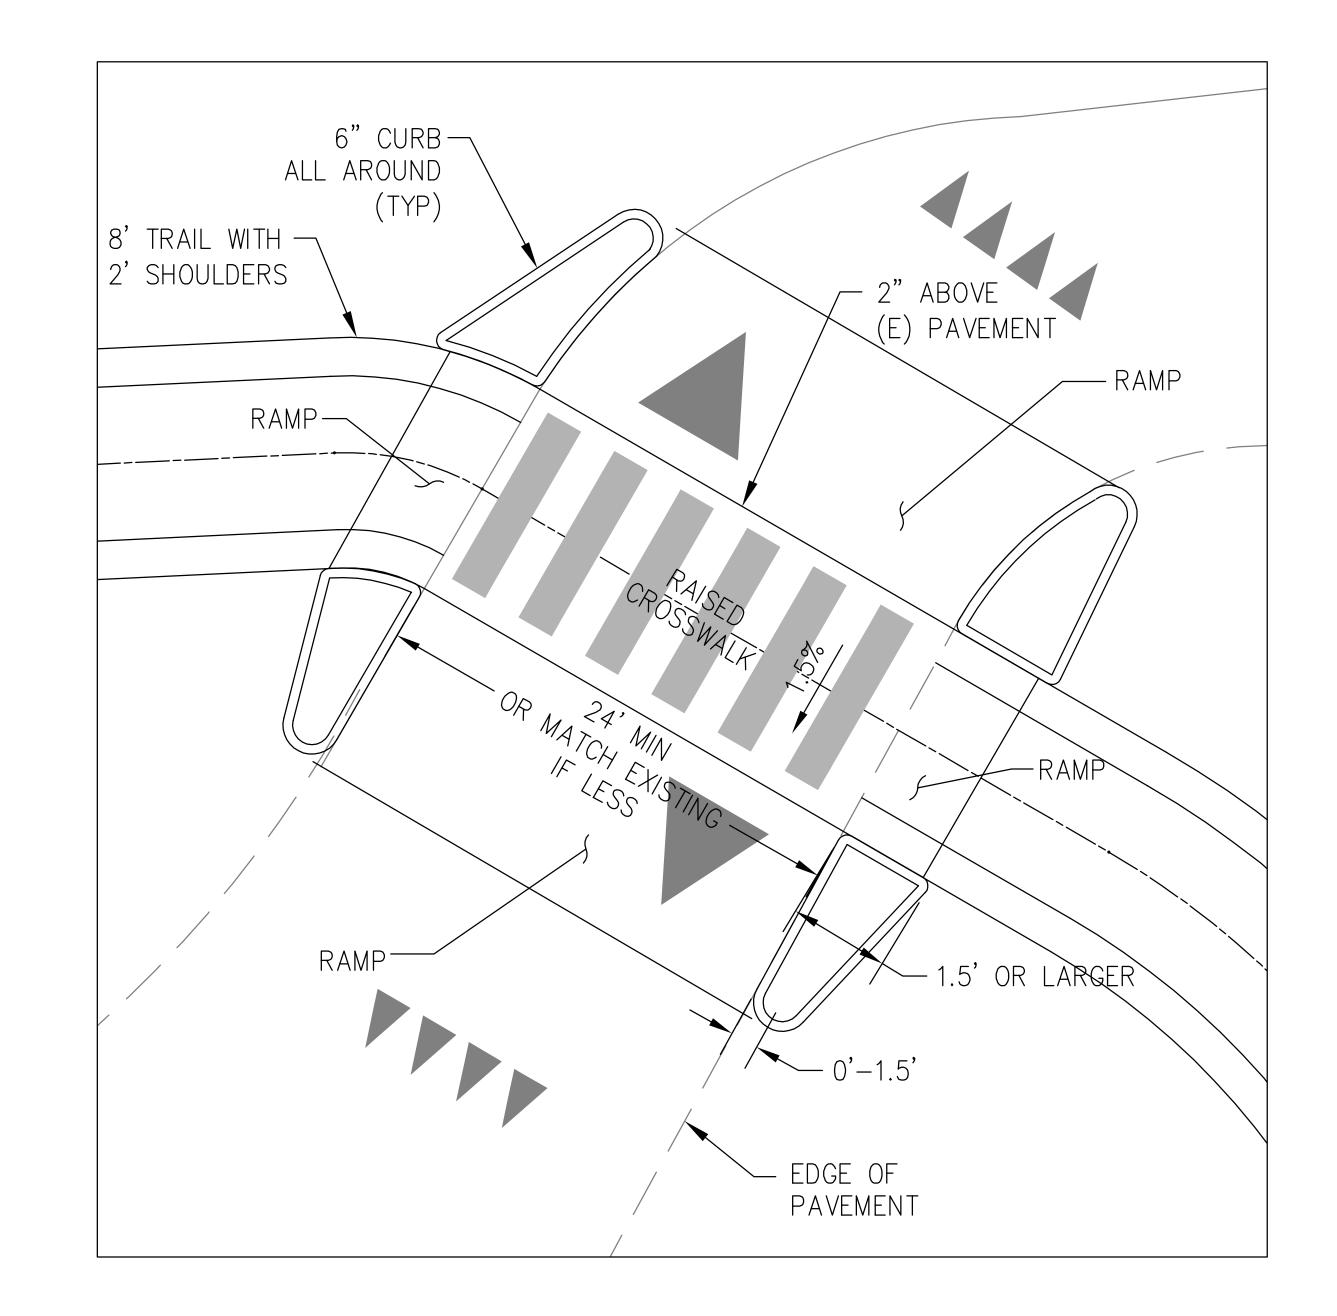

SCALE: 1" = 5'

RAISED CROSSING

NOTES:

- 1. REFER TO PLANS FOR SPECIFIC LAYOUT CONDITIONS.
- 2. REFER TO SIGNING AND STRIPING PLANS FOR MORE INFORMATION.

ADDDOVED DATE	T
APPROVED DATE:	_
JASON MANSFIELD, PROJECT MANAGER	
BKF ENGINEERS	
R.C.E. # 59567 / EXPIRES 12-31-2017	

ENGINEERS / SURVEYORS / PLANNERS	<u> </u>
255 SHORELINE DRIVE, SUITE 200 REDWOOD CITY, CA 94065 (650) 482-6300	

		DESIGNED BY: CT		MIDCOAS		-MODAL TRAII	SCALE: 1" = 5'
			_	MIDCOAS			DATE: 5/20/16
			\dashv		DETAI	ILS	FILE NO.: 1 /XX
					WODKS	555 COUNTY CEN	/
REVISION	DATE	ł	•		WORKS		·
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							SHEET 21 OF
	REVISION	REVISION DATE FOR REDUCED P		CHECKED BY: JM DRAWN BY: FC JAMES C. PORTER, DIRECTOR SAN MATEO CO FOR REDUCED PLANS CHECKED BY: JM DRAWN BY: FC JAMES C. PORTER, DIRECTOR SAN MATEO CO 1	CHECKED BY: JM DRAWN BY: FC JAMES C. PORTER, DIRECTOR OF PUBLIC SAN MATEO COUNTY FOR REDUCED PLANS CHECKED BY: JM DRAWN BY: FC JAMES C. PORTER, DIRECTOR OF PUBLIC SAN MATEO COUNTY	CHECKED BY: JM DRAWN BY: FC JAMES C. PORTER, DIRECTOR OF PUBLIC WORKS SAN MATEO COUNTY FOR REDUCED PLANS CHECKED BY: JM DETA	CHECKED BY: JM DETAILS DRAWN BY: FC JAMES C. PORTER, DIRECTOR OF PUBLIC WORKS REVISION DATE SAN MATEO COUNTY FOR REDUCED PLANS O 1 2 3 4 FOR REDUCED PLANS

30% SUBMITTAL - FOR REVIEW ONLY






SOLAR LIGHT BOLLARD
NTS

2 TRAIL CROSSING (W11-15, W11-15a, & W11-15P)
NTS


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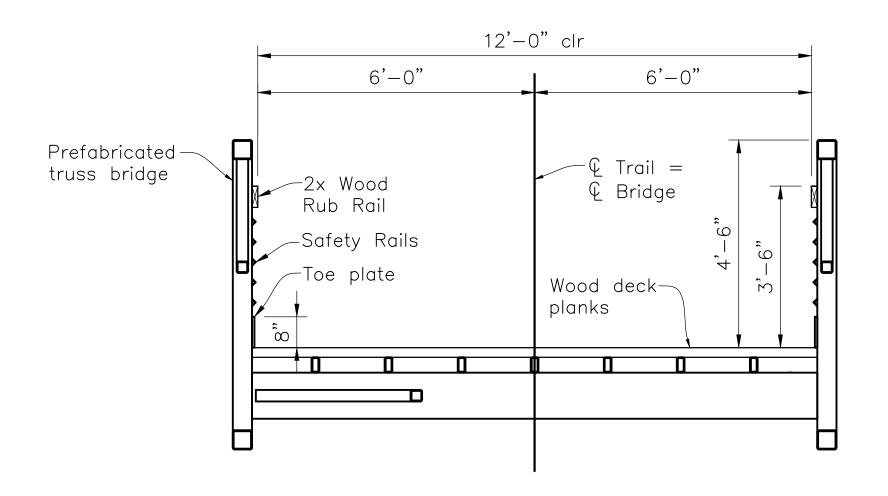
APPROVED DATE:
LACON MANGELE D. DROJECT MANAGER
JASON MANSFIELD, PROJECT MANAGER
BKF ENGINEERS
R.C.E. # 59567 / EXPIRES 12-31-2017

ENGINEERS / SURVEYORS / PLANNERS	///
255 SHORELINE DRIVE, SUITE 200 REDWOOD CITY, CA 94065 (650) 482-6300	$ \setminus $

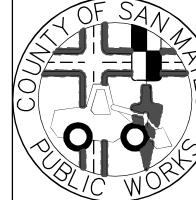

		DESIGNED BY:	СТ	MIDCOAST MULTI-MODAL TRAIL			SCALE: AS SHOWN
		CHECKED BY:	JM	DETAILS			DATE: 5/20/16
		DRAWN BY:	FC			IAILU	FILE NO.: 1/XXXX
		JAMES C.	PORTER,	DIRECTOR OF P	UBLIC WORKS	555 COUNTY CENTER,	5th FLOOR
REVISION	DATE		SAN	MATEO COUNTY		REDWOOD CITY, CALIFOR	RNIA 94063
	FOR REDUCED P ORIGINAL SCALE		0	1	2	3 4	C-6.01 SHEET 22 OF 24



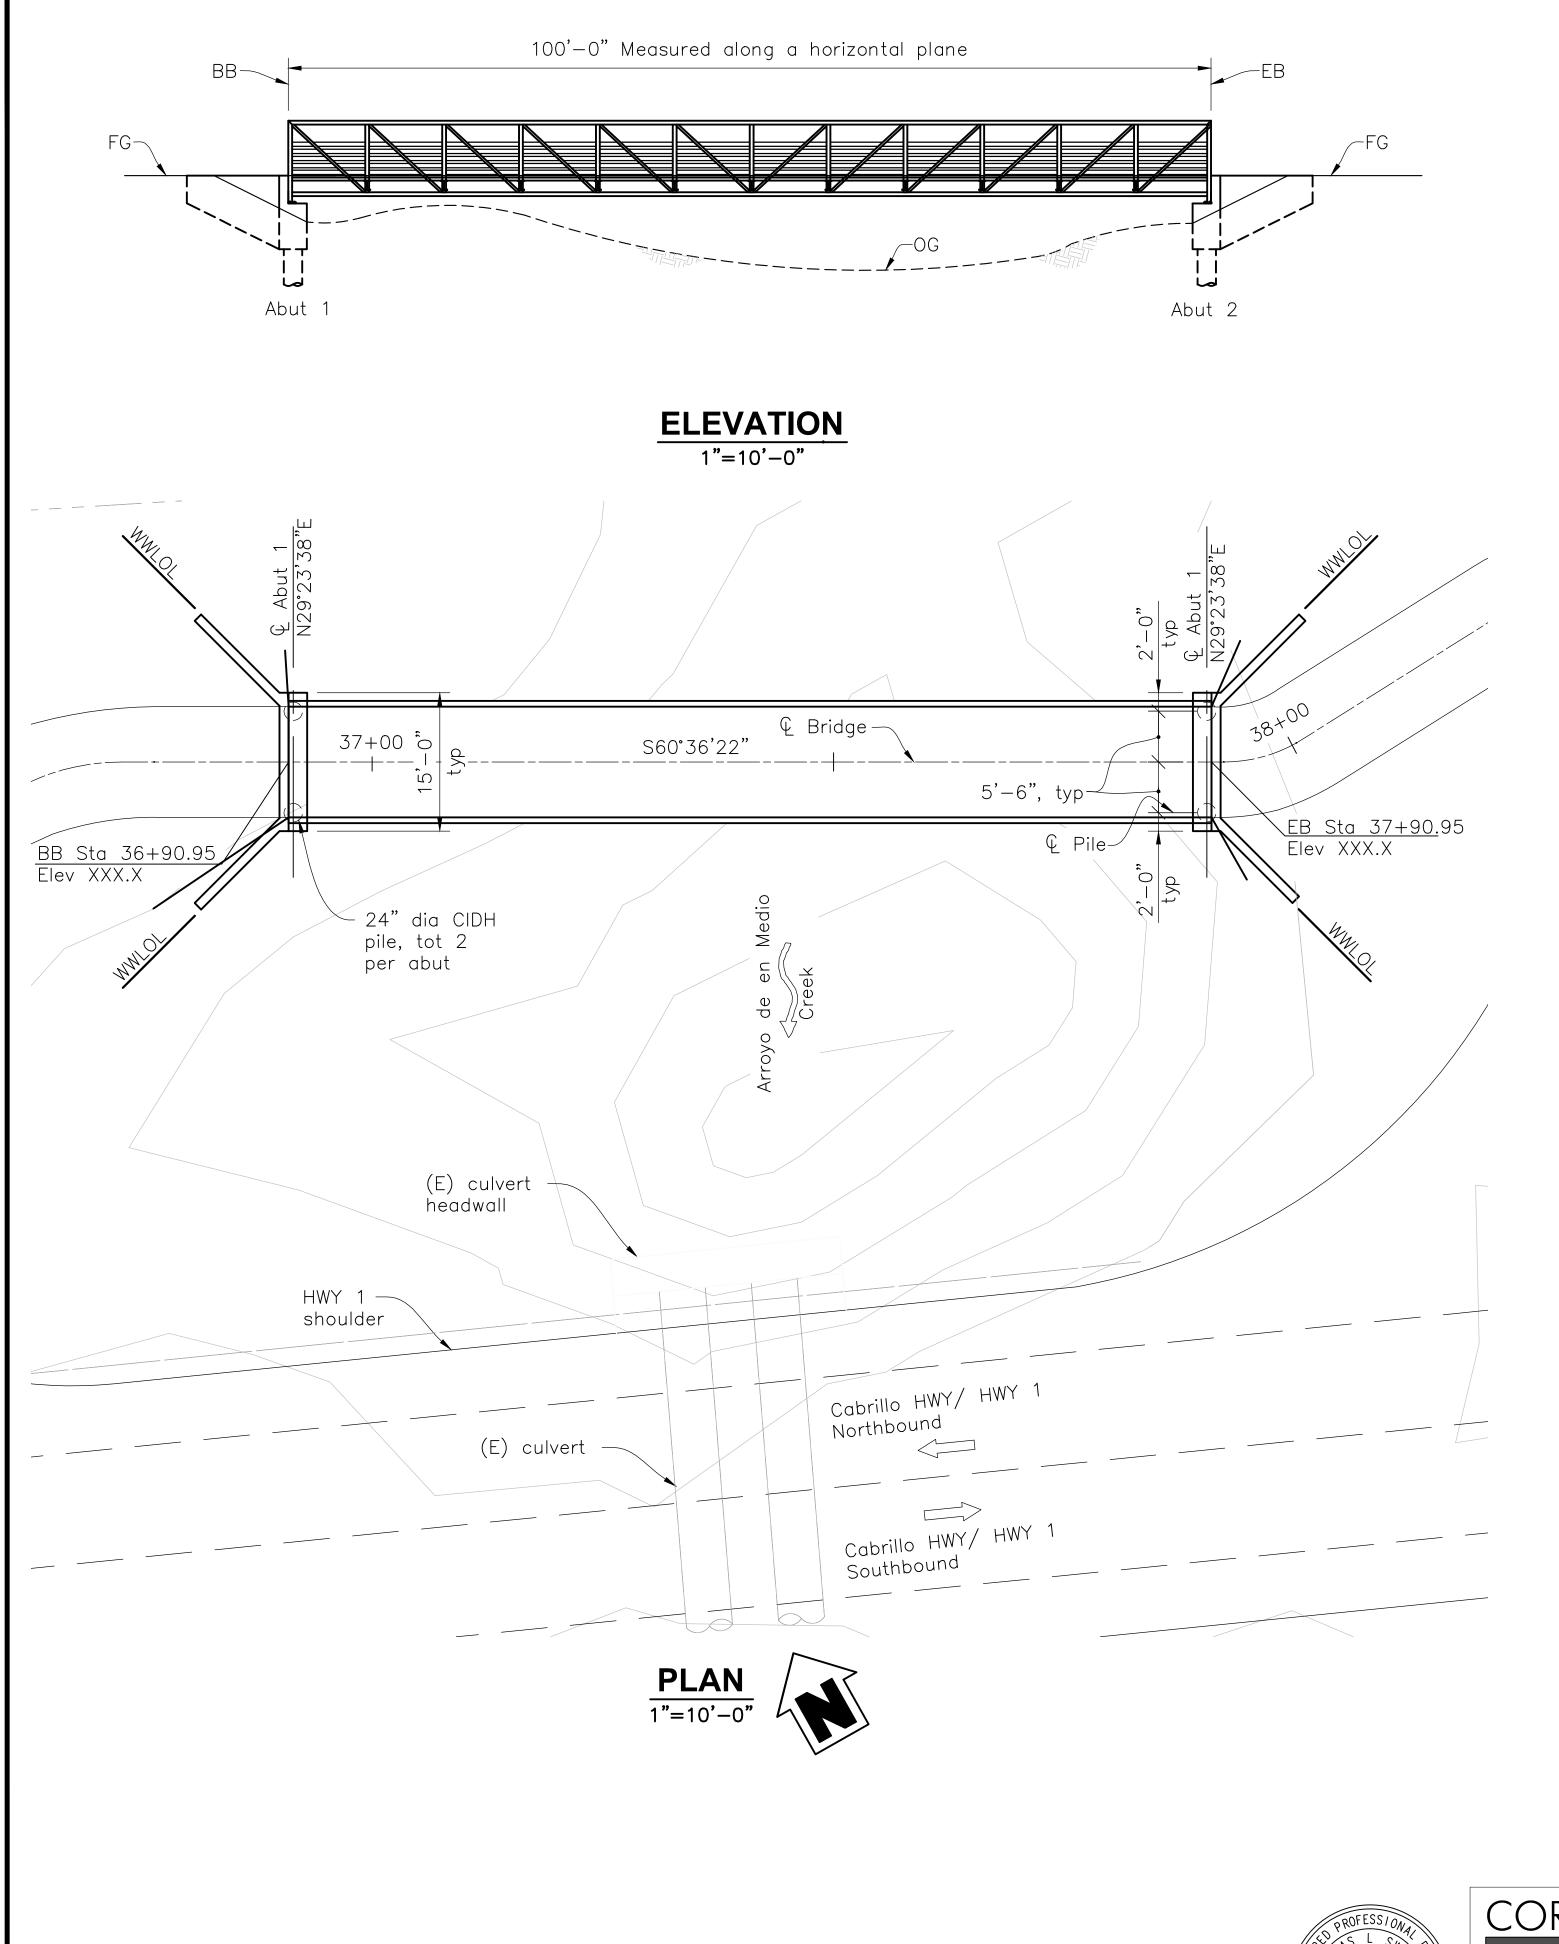



APPROVED:

JAMES C. PORTER, DIRECTOR OF PUBLIC WORKS R. C. E. # 48056 / EXPIRES 12-31-2017

TYPICAL SECTION

1/2"=1'-0"

CALTRANS STANDARD PLANS DATED 2010

A10A ABBREVIATIONS (SHEET 1 OF 2) A10B ABBREVIATIONS (SHEET 2 OF 2) LINES & SYMBOLS (SHEET 1 OF 3) A10D LINES & SYMBOLS (SHEET 2 OF 3) LINES & SYMBOLS (SHEET 3 OF 3) BO−1 BRIDGE DETAILS B0-3 BRIDGE DETAILS B6-10 UTILITY OPENINGS

<u>LEGEND</u>

-Indicates Caltrans standard plan sheet no. − Indicates detail no. A—Indicates section letter Indicates sheet no. shown on 1—Indicates detail no. —Indicates sheet no.

SHEET INDEX

shown on

S1 GENERAL PLAN — BRIDGE S2 GENERAL PLAN — RETAINING WALL

<u>NOTES</u>

- 1. These plans shall incorporate the 2010 State Standard Specifications and 2010 Standard Plans, the 2010 Revised Standard Specifications, and the Special Provisions contained in these plans.
- Prefabricated truss bridge length shall be verified by the Contractor with in-place location of abutments.
- 3. Contractor shall obtain and comply with all permit requirements established for the project.
- 4. Surveyor shall verify layout and elevation control. Contractor shall verify all structure dimensions shown on these plans with the bridge supplier. Any discrepancies must be brought to the attention of the Engineer immediately.
- 6. Section cuts indicated in plan are typical at both abutments.

(650) 482-6300

7. Contours shown are for information only. For existing topography and grading, see Civil Plans.

BRIDGE FOUNDATIONS GENERAL NOTES LOAD AND RESISTANCE FACTOR DESIGN

AASHTO LRFD Bridge Design Specifications, 6th Edition with Caltrans Amendments FOUNDATION DESIGN:

SEISMIC DESIGN: Caltrans Seismic Design Citeria (SDC), Version 1.7, dated April 2013

Bridge Self Weight DEAD LOAD:

90 psf Pedestrian Load & H10 Design Vehicle LIVE LOADING:

ABUTMENT Maximum bridge service loading REACTIONS:

reactions are as follows:

(Includes FWS) Dead Load Utility Dead Load Vehicular Live Load

Seismic Load $V_{s30} = XXXm/s$

SEISMIC LOADING: Moment Magnitude: X.X Peak Ground Acceleration = X.XXXg

5% Damping

1.0 2.0 3.0 4.0 5.0 Period (sec)

ACCELERATION RESPONSE SPECTRUM

SOIL CRITERIA Per Foundation Design Recommendations FOR DESIGN: provided by XXX, dated X/XX/XXXX:

SAN MATEO COUNTY


Soil Unit Weight = XXX pcfUnrestrained Active Pressure (Undrained) = XX pcf

Additional Seismic Earth Pressure = XX x H² Applied at X Ht. of Wall

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CORNERSTONE structural engineering group



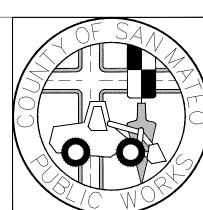

八		
	REVISION	DATE
125		

DESIGNED BY: CDI CHECKED BY: TLS DRAWN BY: CDI JAMES C. PORTER, DIRECTOR OF PUBLIC WORKS

GENERAL PLAN - BRIDGE

MIDCOAST MULTI-MODAL TRAIL


SCALE: AS NOTED DATE: 4/7/16 FILE NO.: 1/XXX 555 COUNTY CENTER, 5th FLOOR

REDWOOD CITY, CALIFORNIA 94063

S1 FOR REDUCED PLANS
ORIGINAL SCALE IS IN INCHES SHEET **22** OF 23

MIRRORED ELEVATION

Horiz: 1"=30'-0" Vert: 1"=5'-0"

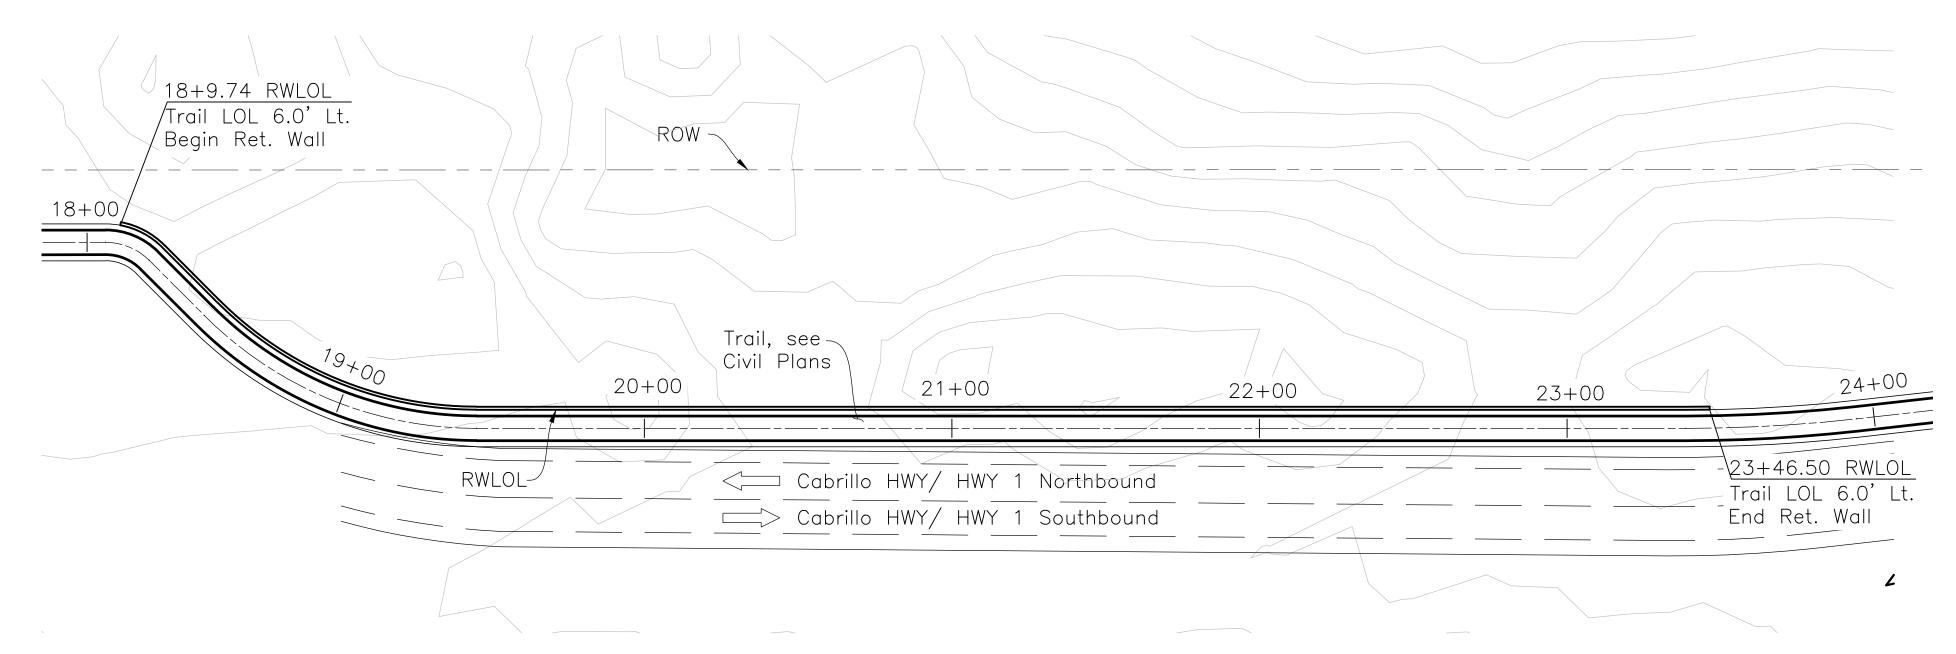




GENERAL NOTES


- 1. These plans shall incorporate the 2010 State Standard Specifications and 2010 Standard Plans, the 2010 Revised Standard Specifications, and the Special Provisions contained in these plans.
- 2. Contractor shall obtain and comply with all permit requirements established for the project.
- 3. Surveyor shall verify layout and elevation control.
- Contractor shall verify all structure dimensions shown on these plans. Any discrepancies must be brought to the attention of the Engineer immediately.
 Contours shown are for information only. For existing topography and grading, see Civil Plans.
- Concrete block walls shall have vertical expansion joints at a maximum spacing of 48'-0".








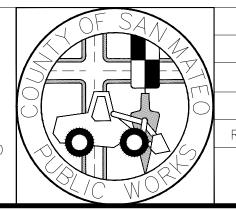

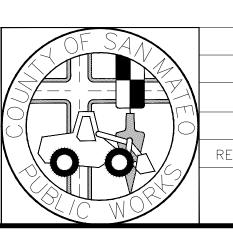

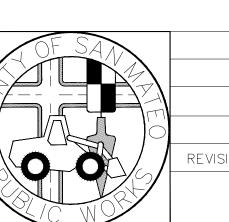

REVISION

DESIGNED BY: CDI MIDCOAST MULTI-MODAL TRAIL SCALE: AS NOTED GENERAL PLAN - RETAINING WALL

FILE NO.: 1/XXX) 555 COUNTY CENTER, 5th FLOOR

REDWOOD CITY, CALIFORNIA 94063 **S2** SHEET 23 OF 23

Highway 1 4'-0"± Shoulder Travel Way Asphalt path 6' chainlink railing RWLOL-Cast-in-place concrete cap ←FG, See guardrail, see Civil Plans Čivil Plans 8x8x16 ~ CMU, typ Approx. OG, — See Civil Plans **TYPICAL SECTION**

APPROVED:

JAMES C. PORTER, DIRECTOR OF PUBLIC WORKS R. C. E. # 48056 / EXPIRES 12-31-2017

DESIGN NOTES Design Specifications: AASHTO LRFD Bridge Design Specifications 6th Edition with California Amendments

1/2"=1'-0"

Masonry

1,500 PSI f'm = 24,000 PSI fs =21.48

Concrete

f'c = 3,600 psify = 60,000 psi

GEOTECHNICAL DESIGN PARAMETERS

Per the geotechnical recommendations for retaining structure by XXX, dated XX/XX/XX:

Retaining Wall

Equivalent Active Fluid Pressures = XX pcf for level backfill Allowable Bearing Pressure = XXXX psf Allowable passive pressure = XXX psf Allowable Friction coefficient = X.XX

Seismic Active Increment = XX pcf (Level) = XXX psf

Lateral Surcharge

30% SUBMITTAL - FOR REVIEW ONLY

DRAWN BY: CDI JAMES C. PORTER, DIRECTOR OF PUBLIC WORKS SAN MATEO COUNTY DATE FOR REDUCED PLANS ORIGINAL SCALE IS IN INCHES